SPECIFICATION

GENERAL NOTES

References

All plans and details included in the project documents shall be read in conjunction with this specification. All structural and civil works components of the landscape design shall be referenced to engineers' details and specifications. Read this specification in conjunction with the plant and materials schedules on the drawings. If in doubt about any detail or if conflicts are found in the documents, seek advice.

Workmanship and Materials

The whole of the landscape works shall be carried out by a competent. trained and qualified landscape contractor who is experienced in horticultural practices, landscape construction and planting techniques. The landscape contractor shall hold a current Building Contractors License and/or be a financial member of LNA Landscape Association NSW & ACT or equivalent organisations in other states.

EARTHWORKS

Excavation, Trimming and Filling

Except as otherwise noted in the contract, bulk excavation is excluded from the landscape works. After the completion of bulk excavation by others, trim and fill the excavated ground surfaces to achieve design levels to accommodate finish materials as detailed. Prepare the sub-grade surface as required for the various finished ground treatments.

Sub-soil Drainage

Keep the excavated works drained and free of standing water. Allow to supply and install sub-soil drainage pipes as required for the new works to ensure that all gardens are well drained. Connect the sub-soil drainage pipes to the nearest downstream stormwater pits. Include pipe filter socks and course sharp aggregate backfilling of trenches.

HARDWORKS

Furniture, Handrails, Balustrades

Supply and install the scheduled items in accordance with the manufacturer's recommendations, as detailed and in the locations shown on plan. Provide all footings and fixings required for the items to be stable and in accordance with applicable codes and standards.

Garden Walls, Fences, Steps, TGSI and Edging

Construct garden walls, fences, steps, TGSI and edging as shown on plan, as detailed and of the material scheduled. Provide footings, step nosings, tactile surfaces to comply with Australian Standards and applicable legislation. Refer to engineer's details for structural retaining walls, concrete stairs, concrete strength, reinforcing and joint placement.

Continuous, Unit and Loose Pavement

Install the scheduled material pavement to the locations shown on plan. Ensure that all subgrade/subsurface works are complete prior to commencing paving. Confer with the engineer to ensure the structural integrity of the subgrade. Ensure that the base course under paved surfaces is a continuous plane offering a constant depth of bedding material not exceeding 50mm. If laying unit pavers in a cement mortar bed on a concrete sub-base ensure that joints in paving match the location of joints in the concrete. Refer to engineer's details for heavy duty slabs, concrete stairs, concrete strength, reinforcing, and joint type and placement.

SOFTWORKS

Site Soil Testing

Where site soil is to be retrieved from site and stored on site for reuse, undertake at least two (2) soil tests in locations as advised by the Project Manager or as shown on the plans. Provide results and recommendations regarding soil additives for the benefit of healthy plant growth and to adjust the soil components to achieve an appropriate planting medium for successful plant development.

Subsoil

Excavate and/or fill all garden beds to bring the top of subsoil to at least 300mm below finished design soil levels. Excavate all turf areas to bring the subsoil to at least 100mm below finished design levels. In all areas shape the subsoil to fall to subsoil drains where applicable. Do not excavate within the drip line of trees and shrubs to be retained. Cultivate or rip the subsoil to a further depth of 100mm before placing top soil. Remove stones of size exceeding 25mm, clods of earth exceeding 50mm, and weeds, rubbish or other deleterious material brought to the surface during cultivation. Do not disturb services or existing tree roots. If necessary cultivate these areas by hand. During cultivation, thoroughly mix in materials required to be incorporated into the subsoil, as recommended in the soil testing results and to manufacturer's recommendations. Trim the surface to design levels again after cultivation.

Topsoil

Import topsoil for the garden and turf areas, unless the topsoil can be provided from material recovered from the site, as recommended in the soil testing results. Spread the topsoil on the prepared subsoil and grade evenly, compact lightly and uniformly in 150mm layers. Avoid differential subsidence and excess compaction and produce a finished topsoil surface which has the following characteristics:

- Finished to design levels, allowing for mulch or turf, which is to finish flush with adjoining hard surfaces such as paths and edges;
- Smooth and free from inorganic matter, stones or clods of soil;
- Graded to drain freely, without ponding, to catchment and/or sub-soil drains:
- Graded evenly to adjoining surfaces; and
- Ready for planting.

Compost

Provide, in accordance with AS 4454, well rotted vegetative material or animal manure, free from harmful chemicals, inorganic matter, grass, weeds and the reproductive parts of unwanted plants.

Fertiliser

Provide proprietary fertilisers, delivered to the site in sealed containers marked to show manufacturer or vendor, weight, fertiliser type, N:P:K ratio, recommended uses, application rates and safety procedures. Apply appropriate fertiliser suited to the provenance of plants (indigenous or exotic) included in the design.

Plants

Supply plants in accordance with the landscape design drawings and schedules. which have the following characteristics:

- Large healthy root systems, with no evidence of root curl, restriction or damage;
- Vigorous, well established, free from disease and pests, of good form consistent with the species/variety;
- Hardened off, not soft or forced, and suitable for planting in the natural climatic conditions prevailing at the site in full sun, partial shade or full shade conditions:
- Grown in final containers for not less than twelve weeks;
- Trees, unless required to be multi-stemmed, shall have a single leading shoot; and
- Containers shall be free from weeds and of appropriate size in relation to the specified plant size.

Plant Installation

Following excavation of the planting hole, place and spread 15gms of wetting agent pre-mixed with one (1) litre of water. Place the plant correctly orientated to north or for best presentation. Backfill the planting holes with specified topsoil mixture. Lightly tamp and water to eliminate air pockets. Ensure that the backfill soil is not placed over the top of the root ball and that the root ball is not higher than the soil in which it is planted. Apply fertiliser, as specified around the plants in the soil at the time of planting.

Embankment Stabilisation

Where necessary and shown on the drawings prevent soil erosion or soil movement by stabilising embankments as follows. As a minimum this should be on slopes steeper than or equal to 1:3 gradient. Stabilise embankments using biodegradable fibre reinforced heavy weight jute fabric. Lay fabric from top to bottom of slope. Install in accordance with manufacturer's specification, including 300 x 300mm anchor trench at top and bottom of slope, backfilled with soil over the fabric and compacted into the trenches. Using U-shaped galvanised steel pegs at 1000 mm centres generally and 250mm centres at edge overlaps, secure the fabric to the prepared soil surface. Plant through the fabric after it is installed.

Root Barrier

Supply and install root control barriers to all new tree plantings adjacent to walls, paths, kerbs and all service trenches, where their proximity poses a threat to the stability of the built infrastructure. Install in accordance with manufacturer's recommendations.

Mulch

Unless noted otherwise, mulch shall be approved proprietary recycled wood fibre or pine bark material. Place mulch in all garden beds to a depth of 75mm after all specified plants are installed. Keep mulch clear of all plant stems and rake to an even plane, flush with the surrounding surfaces evenly graded between design surface levels. Over fill to allow mulch to settle to the specified depth.

Stakes and Ties

Stakes shall be durable hardwood, straight, free of knots and twists, pointed at one end, in the following quantities and sizes for each of the various plant pot sizes:

- Plants >25 lt: 1 off 38 x 38 x 1200mm;
- Semi-advanced plants >75 lt: 2 off 50x50x 1800mm;
- Advanced plants >100 lt: 3 off 50 x 50 x 2400mm.

Turf

Turf shall be delivered to site as 25mm minimum thick cut rolls. Obtain turf from a specialist grower of cultivated turf. Turf shall have an even thickness, free from weeds and other foreign matter. Deliver turf to the site within 24 hours of being cut and lay it within 24 hours of delivery. Prevent it form drying out between cutting and laying. Lay the turf in the following manner:

- In stretcher pattern, joints staggered and close butted;
- Parallel long sides of level areas, with contours on slopes; and
- To finish flush, after lightly tamping, with adjacent finished surfaces and desian levels.

Species: Stenotaphrum secundatum Sir Walter Soft-leaf Buffalo.

IRRIGATION Scope: Unless otherwise noted or instructed irrigate all planted areas shown on plans including planters, tubs, gardens, turf and the like. The irrigation system shall be an automatic permanent system, with an irrigation controller self operated via a soil moisture sensor. The system shall be calibrated to deliver the optimum rate and volume of water appropriate to the type of plants in the design. The system shall be adjustable and fully serviceable. The layout of the entire irrigation system shall focus on delivering the required amount of water to maintain healthy and vigorous growth. The irrigation system shall be such that, component theft, vandalism, over-spray and wetting of paths shall be reduced to a minimum or completely eliminated by the use of drip, pop-up sprinklers and judiciously placed fixed spray emitters. Generally do not use fine mist emitters that provide a drifting mist that may wet paths and the buildings unless specifically required by the design

LANDSCAPE MAINTENANCE

shall include, but not be limited to:

- Replacing failed plants; • Pruning;
 - Insect and pest control; • Fertilising;
 - Maintaining and removing stakes and ties;
 - Maintaining mulch;
 - Mowing and top dressing;
 - Irrigation and watering; • Erosion control; and
 - Weeding and rubbish removal.

Maintenance Log Book

Implement and keep a maintenance log book recording when and what maintenance work has been undertaken and what materials, actions and decisions have been used, implemented and concluded to keep the landscape always looking its best. Enter data daily and review information every 2 weeks. Observe trends and develop a maintenance regime around seasonal and observed event occurrences.

The Landscape Contractor shall rectify defects during installation and that

become apparent in the works under normal use for the duration of the

contract Defects Liability Period. Unless contracted otherwise, the

Landscape Contractor shall maintain the contract areas by the

implementation of industry accepted horticultural practices for 52 weeks

from Practical Completion of the works. The landscape maintenance works

Maintenance Activities

During the defects maintenance period schedule the following activities to occur on a timely basis.

- Plant replacement Replace plants that have failed to mature, die or are damaged. Replacement plants shall be in a similar size and quality and identical species or variety to the plant that has failed. Replacement of plants shall be at the cost of the landscape contractor unless advised otherwise. If the cause of the failure is due to a controllable situation then correct the situation prior to replacing plants. Observe and replace failed plants within 2 weeks of observation.
- **Pruning** Prune dead wood, broken limbs, dead or infected foliage and as needed to develop strong, healthy plants to achieve the shape and form expected of the plant type. Observe daily and prune plants on a needs basis.
- **Insect, disease and pest control** Avoid spraying:
- \circ if ever possible; o in wet weather or if wet weather is imminent;
- if target plants are still wet after rain; 0
- in windy weather; and 0
- if non-target species are too close. 0

Immediately report to the Project Manager any evidence of intensive weed infestation, insect attack or disease amongst plant material. Submit all proposals to apply chemicals and obtain approval before starting this work. When approved, spray with herbicide, insecticide, fungicide as appropriate in accordance with the manufacturers' recommendations. Observe daily and act as necessary to control any infestation or disease. Record in the logbook all relevant details of spraying activities including

- Product brand / manufacturer's name.
- Chemical / product name, Chemical contents,
- Application quantity and rate,
- Date of application and location, 0
- Results of application, and 0
- Use approval authority. 0
- Fertilising Fertilise gardens with a proprietary slow release fertiliser applied in accordance with the manufacturer's directions and recommendations. Apply 6-12 monthly. Record in the logbook all relevant details of fertilising including:
- Product brand / manufacturer's name.
- Fertiliser / product name, \circ 0 Application quantity and rate, and
- Date of application and location. 0
- Stakes and ties Adjust and replace as required to ensure plants remain correctly staked. Remove those not required at the end of the planting establishment period (Defects Liability Period). Inspect and act at least every 2 weeks.
- **Maintaining mulch** Maintain the surface in a clean, tidy and weed free condition and reinstate the mulch as necessary to ensure correct depth as specified. Observe weekly and replenish mulch as required.
- Mowing and top dressing Mow the turf to maintain a grass height of between 30-50mm. Do not remove more than one third of the grass height at any one time. Remove grass clippings from the site after each mowing. Top dress to a maximum of 10mm to fill depressions and hollows in the surface. Mow weekly/fortnightly in warmer months. Mow monthly or as required in cooler months. Top dress at approximately 6 monthly intervals.
- Irrigation and watering Maintain the irrigation system to sure that each individual plant receives the required amount of water to maintain healthy and vigorous growth. Adjust and calibrate as required. Provide additional watering, if necessary but inspect irrigation weekly and make repairs as necessary.
- **Erosion control** Where necessary, maintain the erosion control fabric in a tidy and weed free condition and reinstate as necessary to ensure control measures are effective where deemed necessary. Inspect every 2 weeks and act to repair any damage as soon as possible
- Weeding and rubbish removal During the plant establishment period remove by hand, rubbish and weed growth that may occur or re-occur throughout all planted, mulched and paved areas. The contractor shall target weeds that are capable of producing a major infestation of unwanted plants by seed distribution. Whenever possible, time weed removal to precede flowering and seed set. Constant observation and removal of weeds is essential.

Symbol	ve Plant Schedule Botanic Name	Common Name	Mature Size	Pot size
round	Floor Plaza		(h x w) (m)	
nounu	Trees & Palms			
Ар	Acer palmtum	Japanese Maple	6x3	75 L
As	Acmena smithii	Lillypilly	12 x 6	75 L
Af Bs	Angophora floribunda Banksia serrata	Rough-barked Apple	20 x 8 6 x 4	75 L 75 L
CGU	Ceratopetatum gummiferum	NSW Christmas Bush	5x3	75 L
Cm	Corymbia maculata	Spotted Gum	30 x 8	75 L
Ca Er	Cupaniopsis anacardioides Elaeocarpus reticulatus	Tuckeroo Blueberry Ash	7 x 5 12 x 5	75 L 75 L
Et	Eucalyptus tereticornis	Forest Red Gum	35 x 12	75 L
Fg	Fraxinus griffithii	Evergreen Ash	8 x 4	75 L
Ga Htr	Gordonia axillaris Hibiscus tiliaceus rubra	Gordonia Red Cottonwood	4 x 4 5 x 3	75 L 75 L
Li	Lagerstroemia indica	Crepe Myrtle	6x3	75 L
La	Livistona australis	Cabbage Tree Palm	25 x 4	5m Clear Tru
ME	Magnolia grandiflora 'Exmouth'	Southern Magnolia	12 x 8	75 L
MLG MTB	Magnolia grandiflora 'Little Gem' Magnolia grandiflora 'Teddy Bear'	Little Gem Magnolia Magnolia Teddy Bear	5 x 3 4 x 3	75 L 75 L
Mf	Malus floribunda	Japanese Crab Apple	4 x 3	75 L
Ма	Melaleuca armillaris	Bracelot Honey Myrtle	5 x 7	75 L
Md	Melaleuca decora	White Feather Honeymyrtle	8 x 3	75 L
Ns Oe	Nyssa sylvatica Olea europea	Tupelo European Olive	7 x 4 6 x 3	75 L 75 L
Pr	Plumeria rubra	Frangipani	6 x 3	75 L
Рс	Pyrus calleryana	Ornamental Pear	8 x 4	75 L
SS TIA	Sapium sebiferum Tibouchina lepidosa 'Alstonville'	Chinese Tallow Lasiandra	6 x 3 6 x 4	75 L 75 L
TI TI	Tristaniopsis laurina	Water Gum	6 x 4 10 x 5	75 L 75 L
Up	Ulmus parvifolia	Chinese Elm	10 x 8	76 L
Wf	Waterhousea floribunda	Weeping Lilly Pilly	15 x 8	75 L
	Shrubs and Accents			
AsM	Acmena smithii 'Minor'	Dwarf Lilly Pilly	3.0 x 2.0	300m m
Aa	Agave attenuata	Agave	1.5 x 1.5	300m m
Ai	Alcantarea imperialis	Giant Bromeliad	1.5 x 1.5	300m m
AnZ Bmy	Alpinia nutans 'Zerumbet' Backhousia myrtifolia	Shell ginger Grey Myrtle	0.8 x 0.8 6.0 x 5.0	300mm 300mm
Be	Banksia ericifolia	Heath Banksia	4.0 x 3.0	300mm
Ву	Beschorneria yuccoides	Mexican Lily	2.0 x 2.0	300m m
Bm	Buxus microphylla Japonica	Japanese Box	1.5 x 1.5	300m m
Cc Cp	Callistemon citrinus Callistemon pinifolius	Crimson Bottlebrush Pine-leaved Bottlebrush	4.0 x 2.0 1.5 x 1.5	300mm 300mm
CR	Cordyline fruticosa 'Ruby'	Ti Plant	2.0 x 1.0	300mm
Ca	Correa alba	White Correa	1.5 x 1.0	300m m
De	Doryanthus excelsa	Gymea Lily	2.0 x 2.0	300mm
Ga GR	<i>Gardenia augusta</i> 'Florida' <i>Gardenia augusta</i> 'Radicans'	Gardenia Gardenia Radicans	1.5 x 1.5 0.5 x 0.8	300mm 300mm
Gj	Grevillea juniperina	Prickly Spider Flower	1.5 x 1.5	300mm
Hb	Hakea bakeriana		2.0 x 2.0	300m m
Ms Mt	Melaleuca squamea Melaleuca thymifolia	Swamp Honey Myrtle Thyme Honey-myrtle	2 .0 x 1.5 0.6 x 1.5	300mm 300mm
Mp	Murraya paniculata	Mock Orange	3.0 x 12.0	300mm
PgR	Photinia glabra 'Rubens'	Photinia	2.5 x 2.5	300m m
Ri	Raphiolepis indica	Indian Hawthorn	1.8 x 2.0	300mm
ROP Sr	Raphiolepis 'Oriental Pearl' Strelitzia reginae	Indian Hawthorn Bird of Paradise	1.5 x 1.5 1.2 x 1.5	300mm 300mm
SC	Syzygium 'Cascade'	Pink Flowering Lillypilly	2.5 x 2.0	300mm
Vt	Viburnum tinus	Laurestinus	3.0 x 2.0	300m m
Wfa WWG	Westringia fruticosa	Coastal Rosemary	2.0 x 2.0	300mm
wwg	Westringia fruticosa 'Wynyabbie Gem'	Coastal Rosemary	1.2 x 1.2	300mm
	Groundcovers and Grasses			
Ao	Agapanthus orientalis	Dwarf Philodendron	1.0 x 1.0	150mm
Aau	Asplenium australasicum Blechnum nudum	Bird's Nest Fern	1.0 x 1.0	150mm
Bn Cg	Carpobrotus glaucescens	Fishbone Water Fern Pig Face	0.7 x 0.5 0.2 x 1.0	150mm 150mm
Dc	Dianella caerulea 'Breeze'	Native Flax	0.5 x 0.5	150mm
Dre	Dianella revoluta	Mauve Flax Lily	0.5 x 0.5	150mm
Dr DSF	Dichondra repens Dichondra argentea 'Silver Falls'	Kidney weed Silver Falls	0.2 x 0.6 0.3 x 1.0	150mm 150mm
Hc	Hedera canariensis	Canary Islanda Ivy	0.3 x 2.0	150mm
Hs	Hibbertia scandens	Snake Vine	0.3 x 2.0	150mm
	Lomandra longifolia	Mat Rush	0.7 x 1.0	150mm
LT Mpa	Lomandra 'Tanika' Myoporum parvifolilum	Fine Leaf Dwarf Lomandra Creeping Boobialla	0.5 x 0.5 0.4 x 1.5	150mm 150mm
Рх	Philodendron 'Xanadu'	Dwarf Philodendron	1.0 x 1.0	150mm
PI	Poa labillardieri 'Eskdale'	Tussock Grass	0.4 x 0.4	150mm
Та ті	Themeda australis	Kangaroo Grass	0.8 x 0.3 0.6 x 6	150mm 150mm
Tj Vh	Trachelospermum jasminoides Viola hederacea	Star Jasmine Native Violet	0.6 x 6 0.1 x 0.3	150mm 150mm
	Community Garden			
CaT	Citus aurantifolia 'Tahiti'	Tahitian Lemon	3 x 2	75 L
CsV CIE	Citrus sinensis 'Valencia' Citus limon 'Eureka'	Valencia Orange Eureka Lemon	4 x 3 3 x 2	75L 75 L
PTP	Pyrus 'Trixzie Pyvert'	Dwarf fruiting pear	2 x 2	75 L 75L
As	Allium schoeneoprasum	Chives	0.3 x 0.3	150mm
Csa	Coriandum sativum	Coriander	0.2 x 0.2	150mm
Mpi Ob	Mentha x pipertia Ocimum basilicum	Peppermint Basil	0.2 x 0.2 0.3 x 0.3	150mm 150mm
00 Ov	Organum vulgare	Oregano	0.3 x 0.3	150mm
Pcr	Pertroselinum crispum	Parsley	0.3 x 0.3	150mm
So	Salvia officinalis	Sage	1.0 x 1.0	150mm
Τv	Thymus vulgaris	Thyme	0.2 x 0.2	150mm

NOTE:

Planting schedule and detail for Bioretention basins and ecological zones including parklands that fall within these zones, are to be subject to specialist ecologist consultant advice and recommendations

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The contractor shall check and verify all work on site (including work by others) before commencing the landscape installation. Any discrepancies are to be reported to the Project Manager or Landscape Architect prior to commencing work. Do not scale this drawing. Any required dimensions not shown shall be referred to the Landscape Architect for confirmation.

D C	For Approval For Approval	PH PH PH	RS	05.07.2021 11.06.2021 07.12.2020
B A	For Approval For Approval	PH		07.12.2020
Issue	Revision Description	Drawn		Date

LEGEND

Key Plan:

Superstar Holding Group P/L

EDMONDSON PARK 164 - 170 Croatia Ave Edmondson Park

Level 1, 3-5 Baptist Street

Redfern NSW 2016



Landscape Architects

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DEVELOPMENT APPLICATION


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Landscape Specifications / Indicative Plant Schedule


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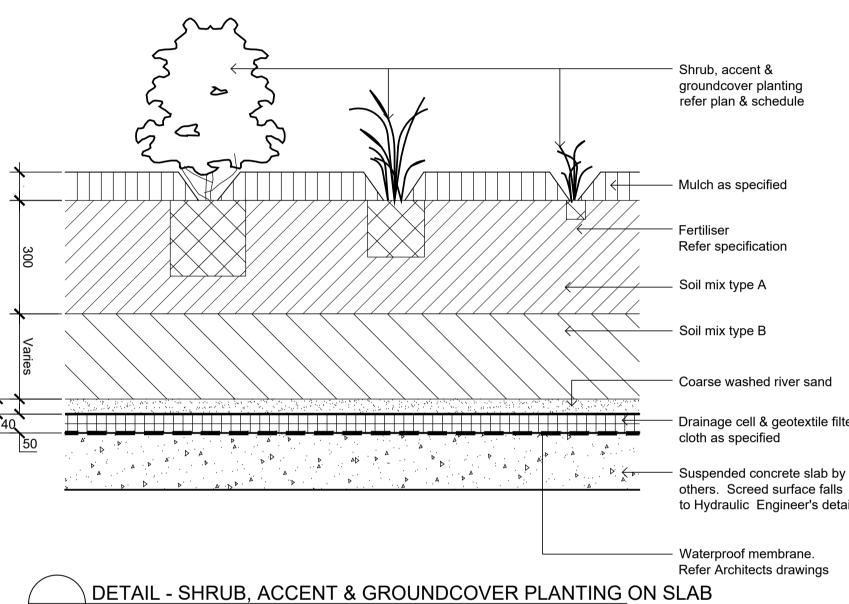
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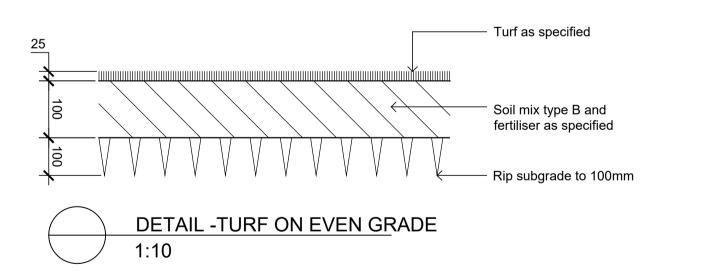
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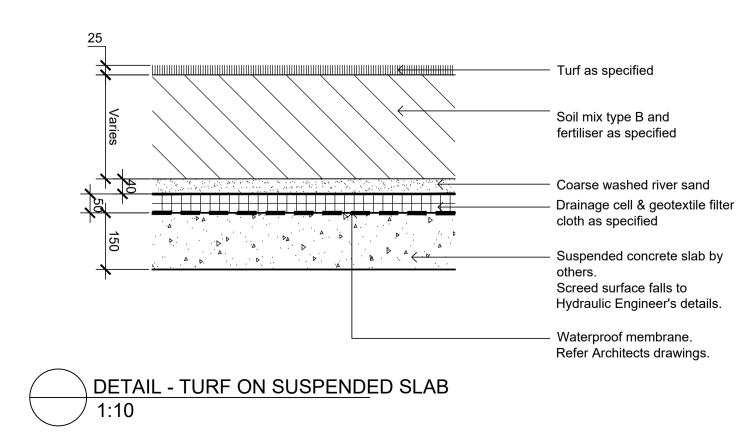
A1





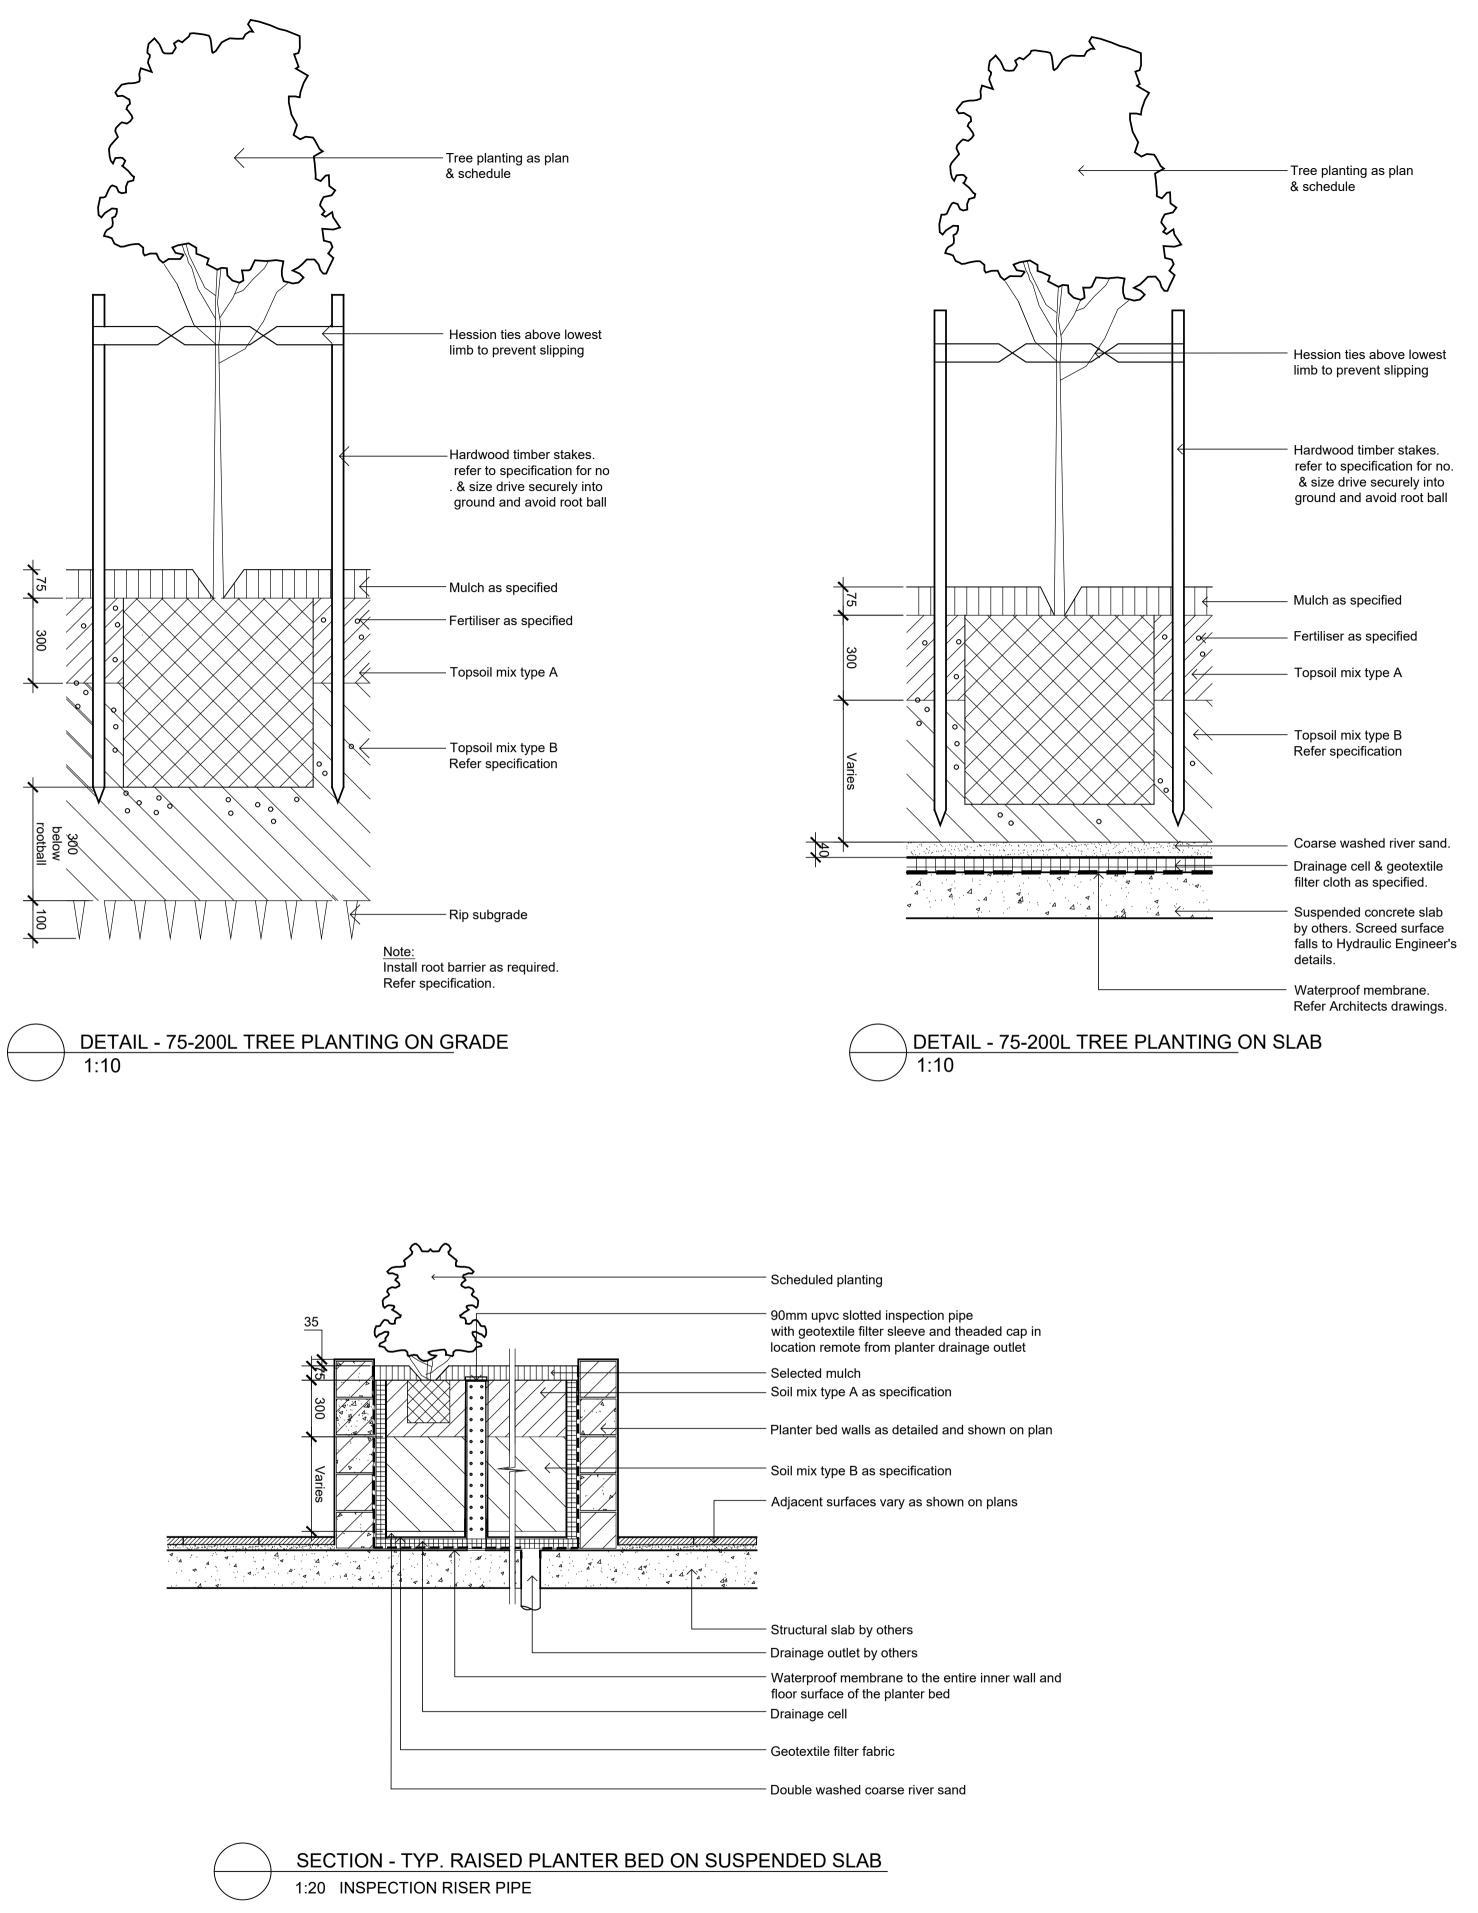

1:10

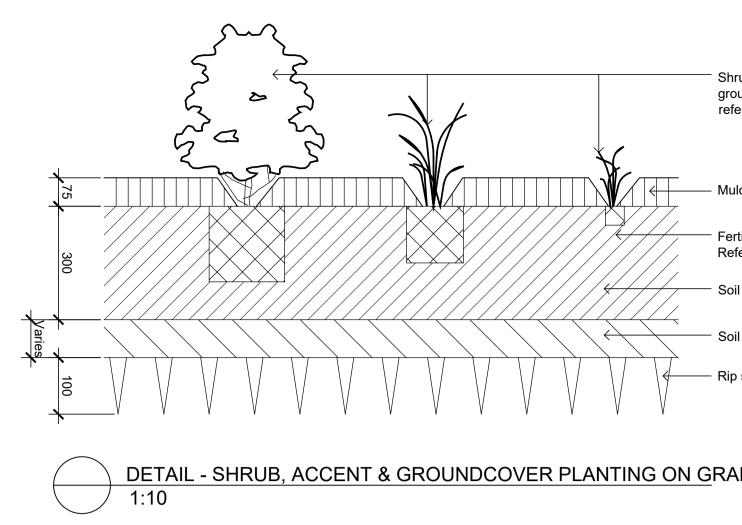

Shrub, accent & groundcover planting refer plan & schedule

- Mulch as specified

Fertiliser Refer specification

- Soil mix type A

Soil mix type B

- Rip subgrade to 100mm

DE		

groundcover planting refer plan & schedule

- Mulch as specified

Refer specification

- Soil mix type A

Soil mix type B

Coarse washed river sand

- Drainage cell & geotextile filter cloth as specified

others. Screed surface falls to Hydraulic Engineer's details.

 Waterproof membrane. Refer Architects drawings

Key Plan:

D For Approval

C For Approval

B For Approval

A For Approval Issue Revision Description

LEGEND

Client: Superstar Holding Group P/L

Project:

Australia

EDMONDSON PARK 164 - 170 Croatia Ave Edmondson Park

Level 1, 3-5 Baptist Street Redfern NSW 2016

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DEVELOPMENT APPLICATION

Drawing Number:

Drawing Name: Landscape Details

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SS20-4427

501 D

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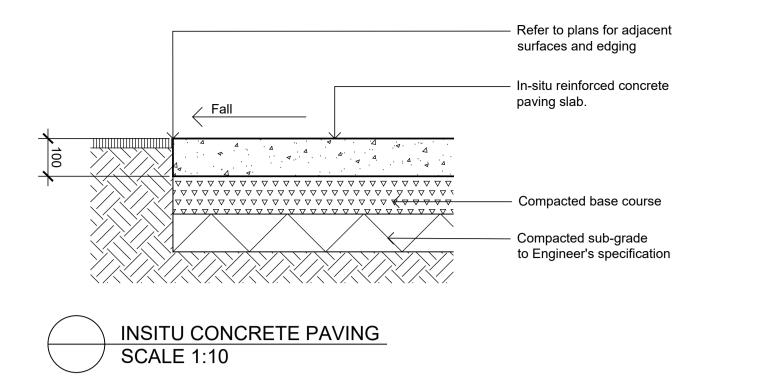
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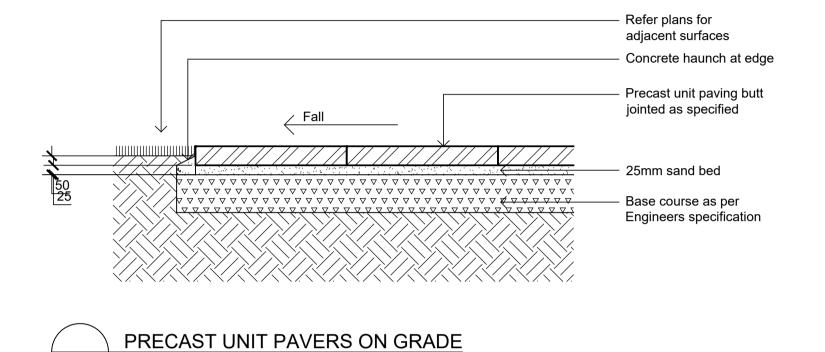
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PH RS 07.12.2020


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Drawn Check Date







SCALE 1:10

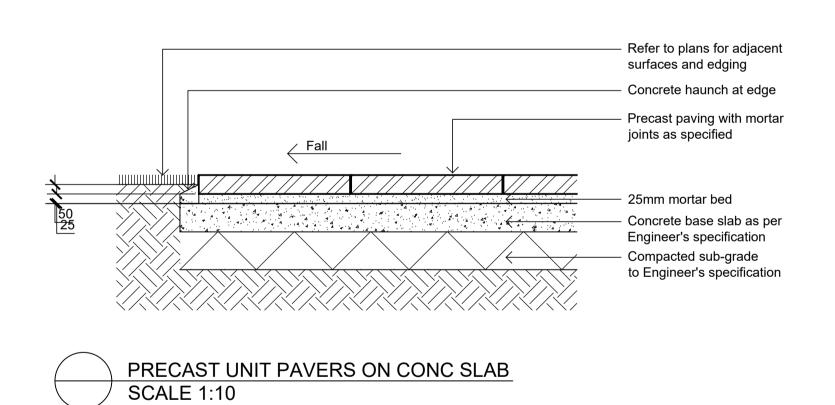

NOT FOR CONSTRUCTION

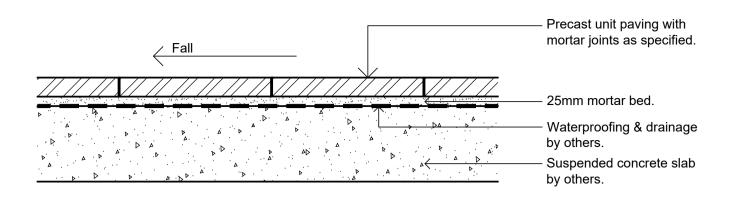

PRECAST UNIT PAVERS ON SUSPENDED SLAB SCALE 1:10

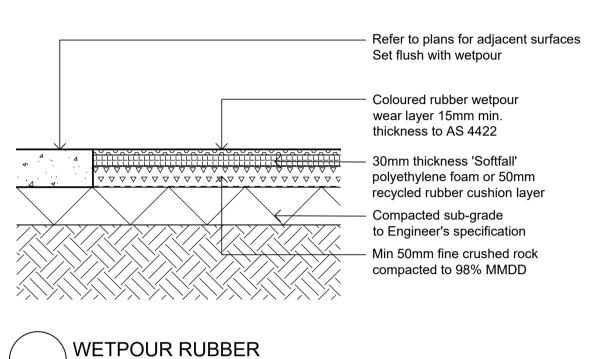

SCALE 1:10

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D C B	For Approval For Approval For Approval	PH PH PH	RS	05.07.2021 11.06.2021 07.12.2020
A	For Approval	PH	RS	03.07.2020
Issue	Revision Description	Drawn	Check	Date

LEGEND

Key Plan:

Client: Superstar Holding Group P/L

Project: EDMONDSON PARK 164 - 170 Croatia Ave Edmondson Park

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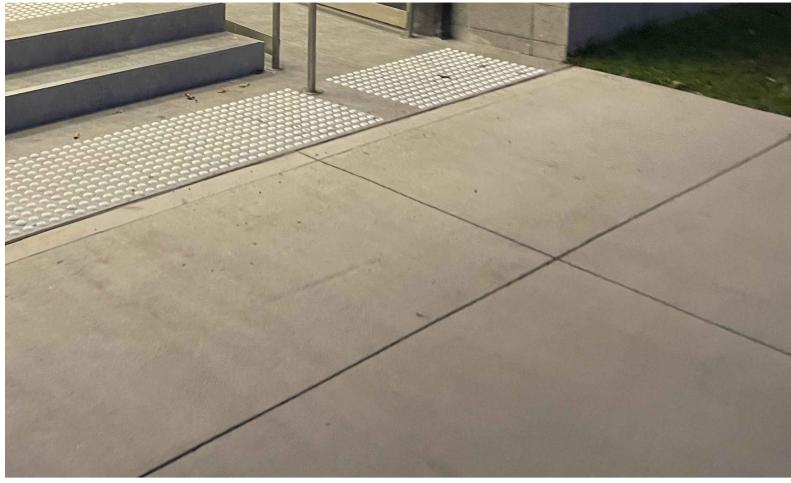
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Drawing Number:

SS20-4427

502 D





Feature paving to main entry stair ways

Broomed concrete path to residential access from street



Indicative bollard style and treatment to crossing and driveways



Indicative shareway seating and activation




Ecotrihex paving to parking bays and shareways



Ecotrihex paving to parking bays and shareways



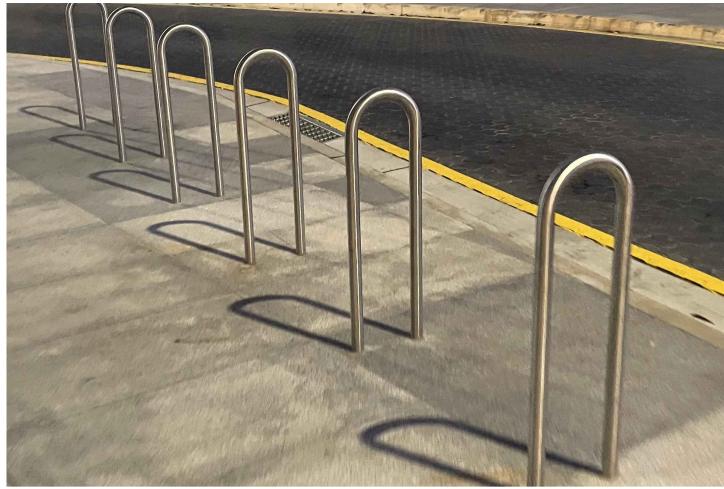

Bike parking to key public accessible spaces



Tree pits with permeable lid

Retail and public domain delineation, wayfinding and activation

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D	For Approval	PH	RS	05.07.2021	
С	For Approval	PH	RS	11.06.2021	
В	For Approval	PH	RS	07.12.2020	
А	For Approval	PH	RS	03.07.2020	
Issue	Revision Description	Drawn	Check	Date	

LEGEND

Key Plan:

Client: Superstar Holding Group P/L

Project: EDMONDSON PARK 164 - 170 Croatia Ave Edmondson Park

Level 1, 3-5 Baptist Street Redfern NSW 2016

Australia



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Drawing Numbe

Drawing Name: Landscape Detail, Imagery & Character


Sheet _ of _

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SS20-4427

503 D

Issue:

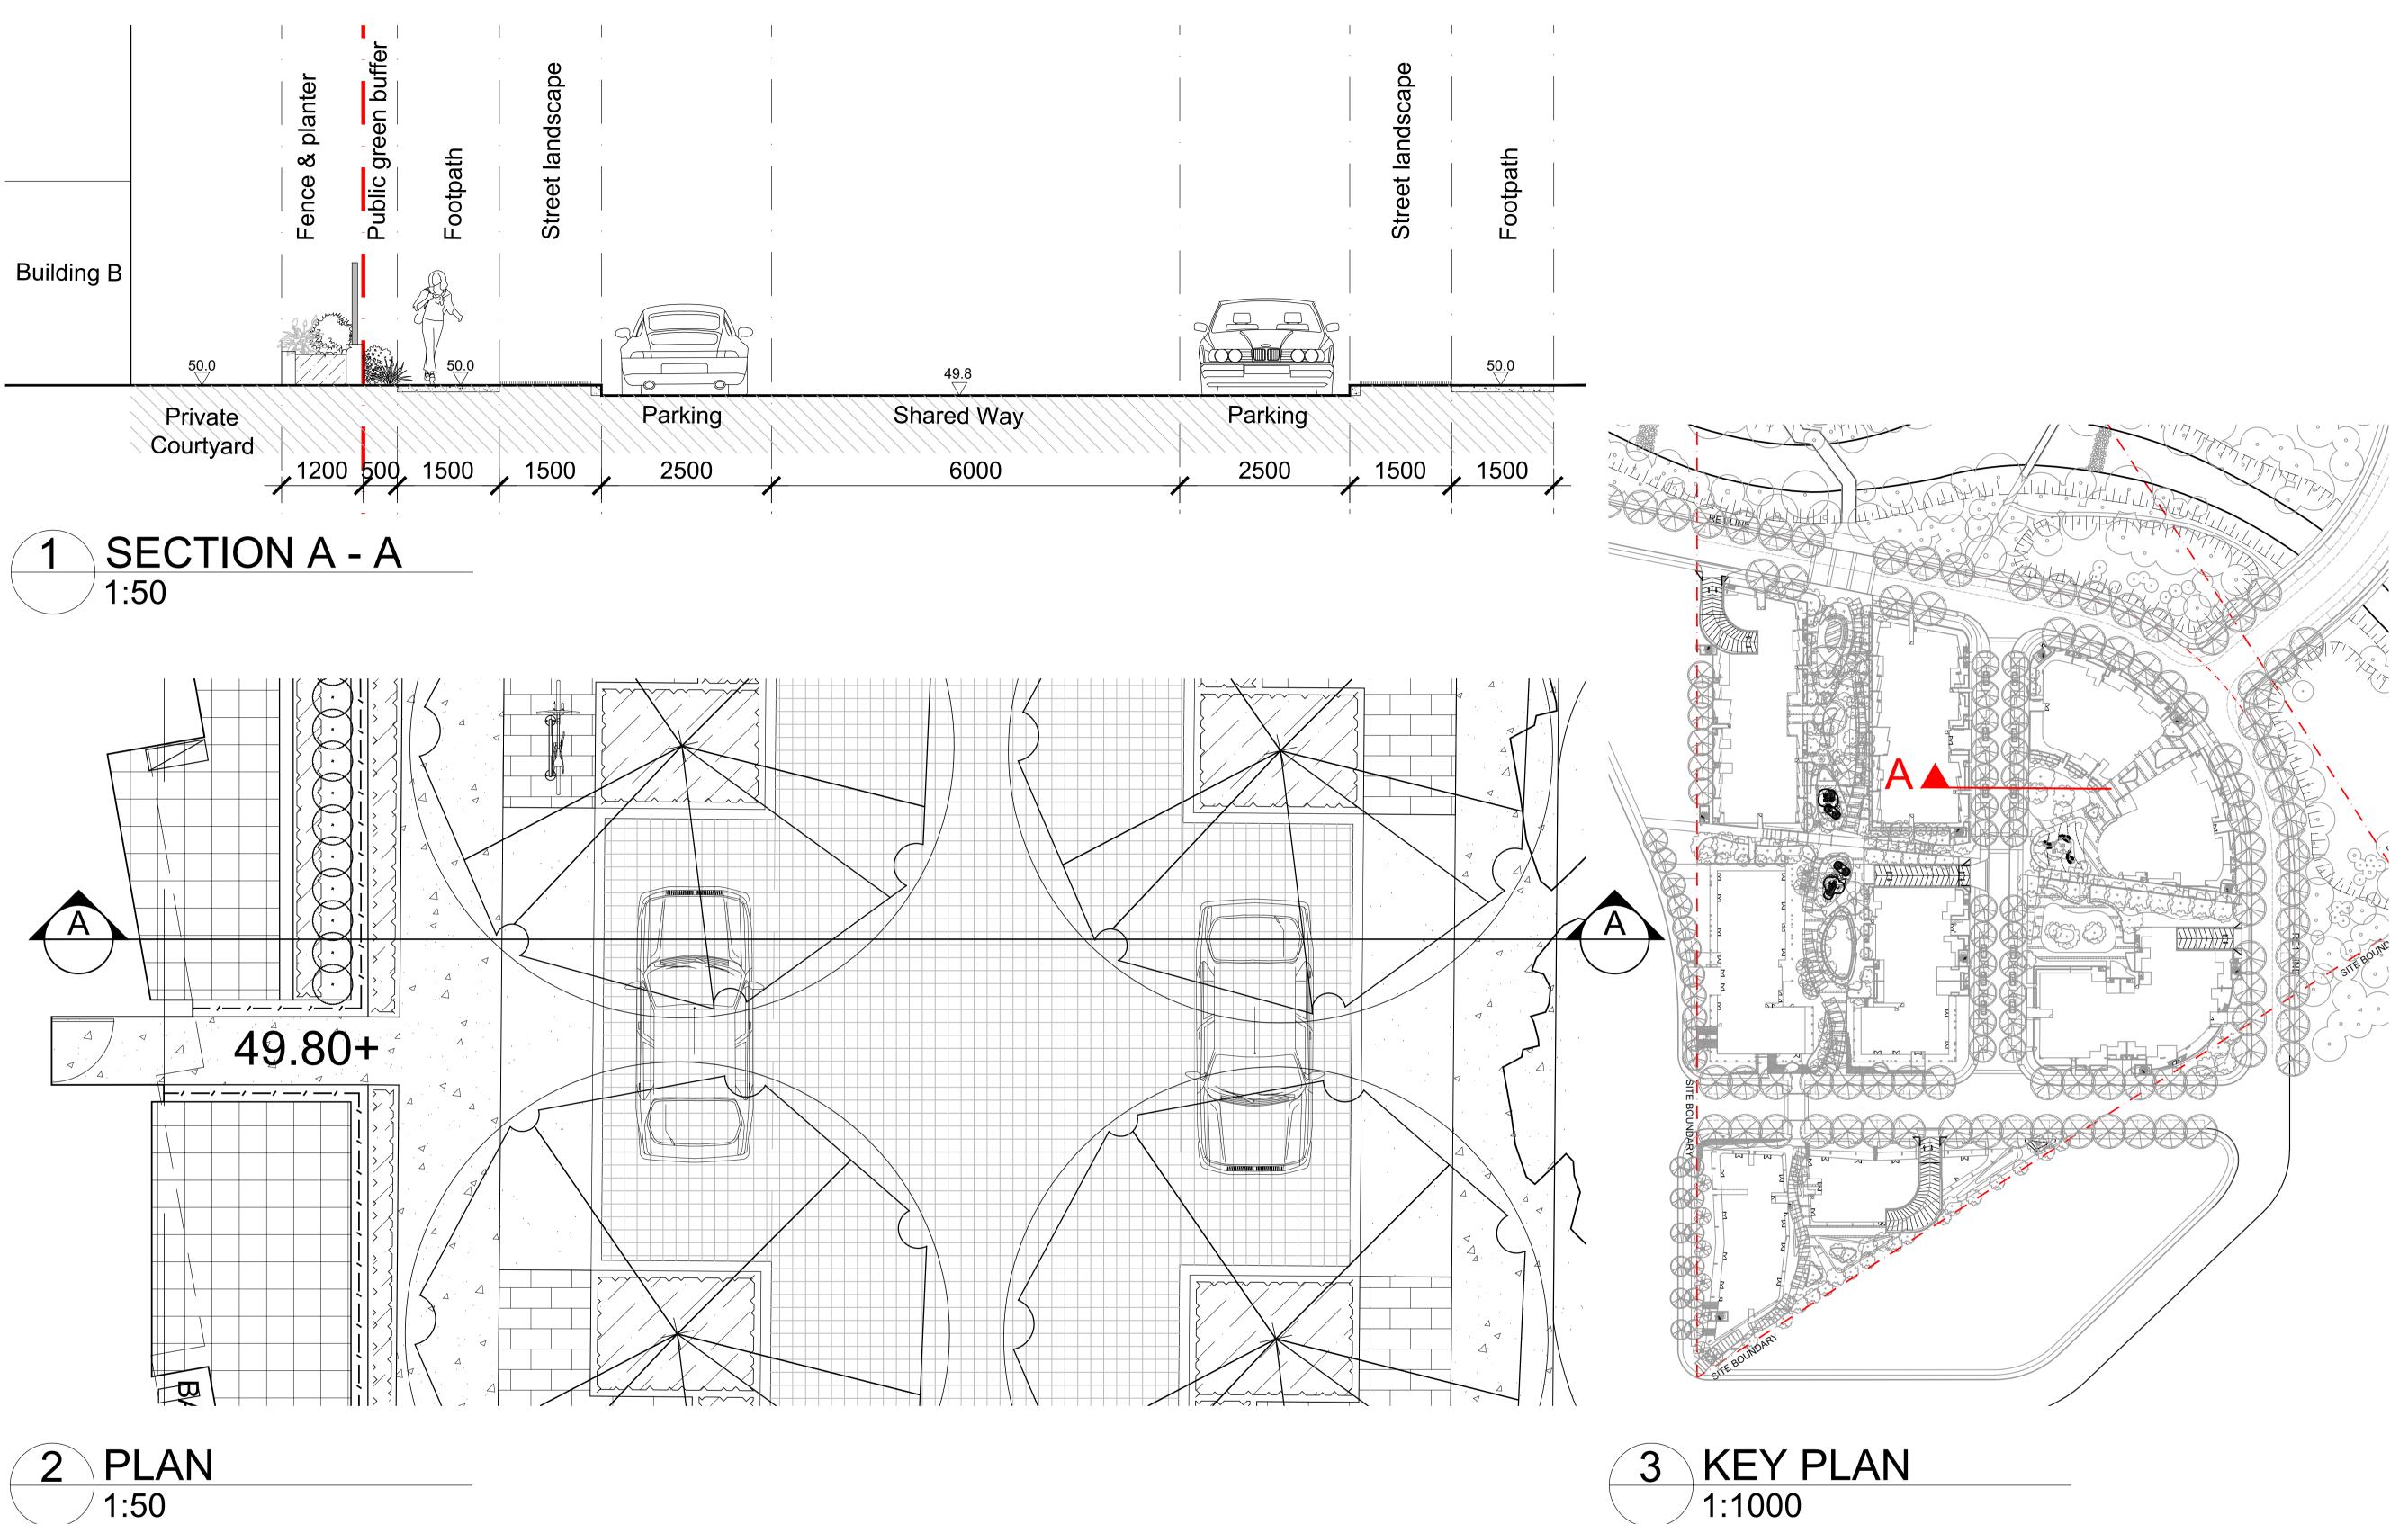

NOT FOR CONSTRUCTION

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С	For Approval	PH	RS	05.07.2021
В	For Approval	PH	RS	11.06.2021
А	For Approval	PH	RS	27.05.2021
Issue	Revision Description	Drawn	Check	Date

LEGEND

Key Plan:

Client: Superstar Holding Group P/L

Project: EDMONDSON PARK 164 - 170 Croatia Ave Edmondson Park

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DEVELOPMENT APPLICATION

Drawing Name: Landscape Sections


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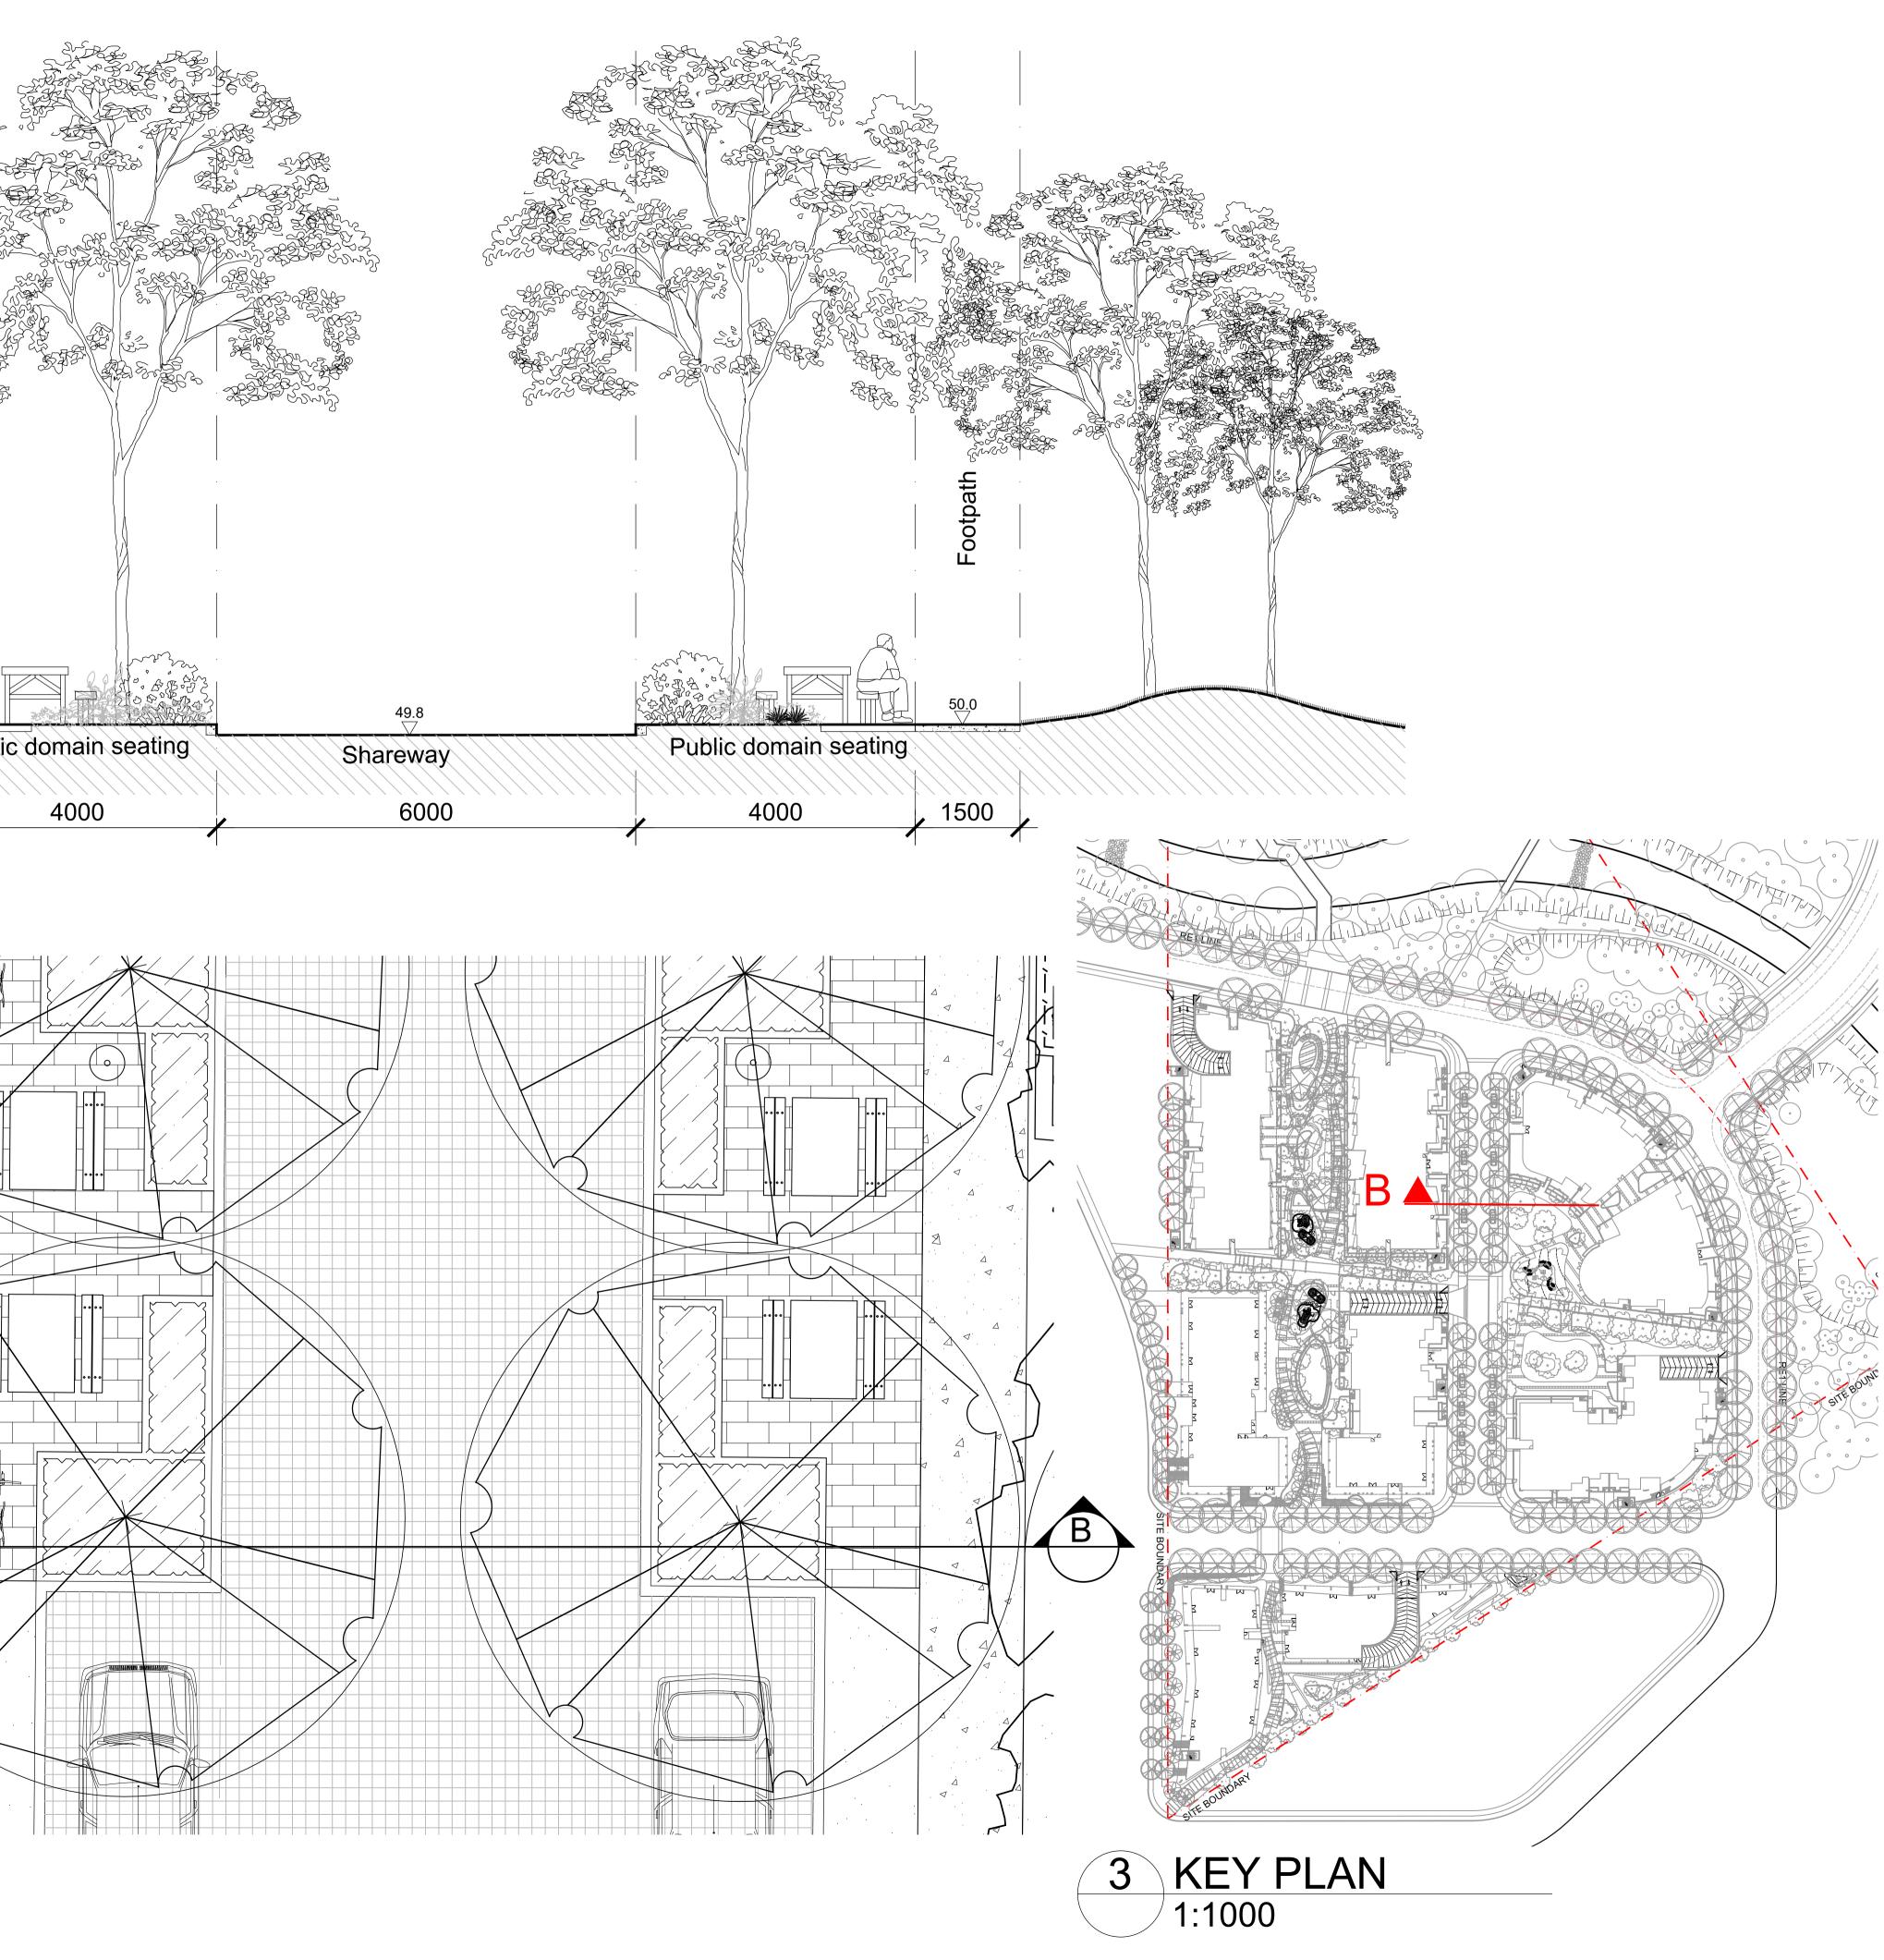
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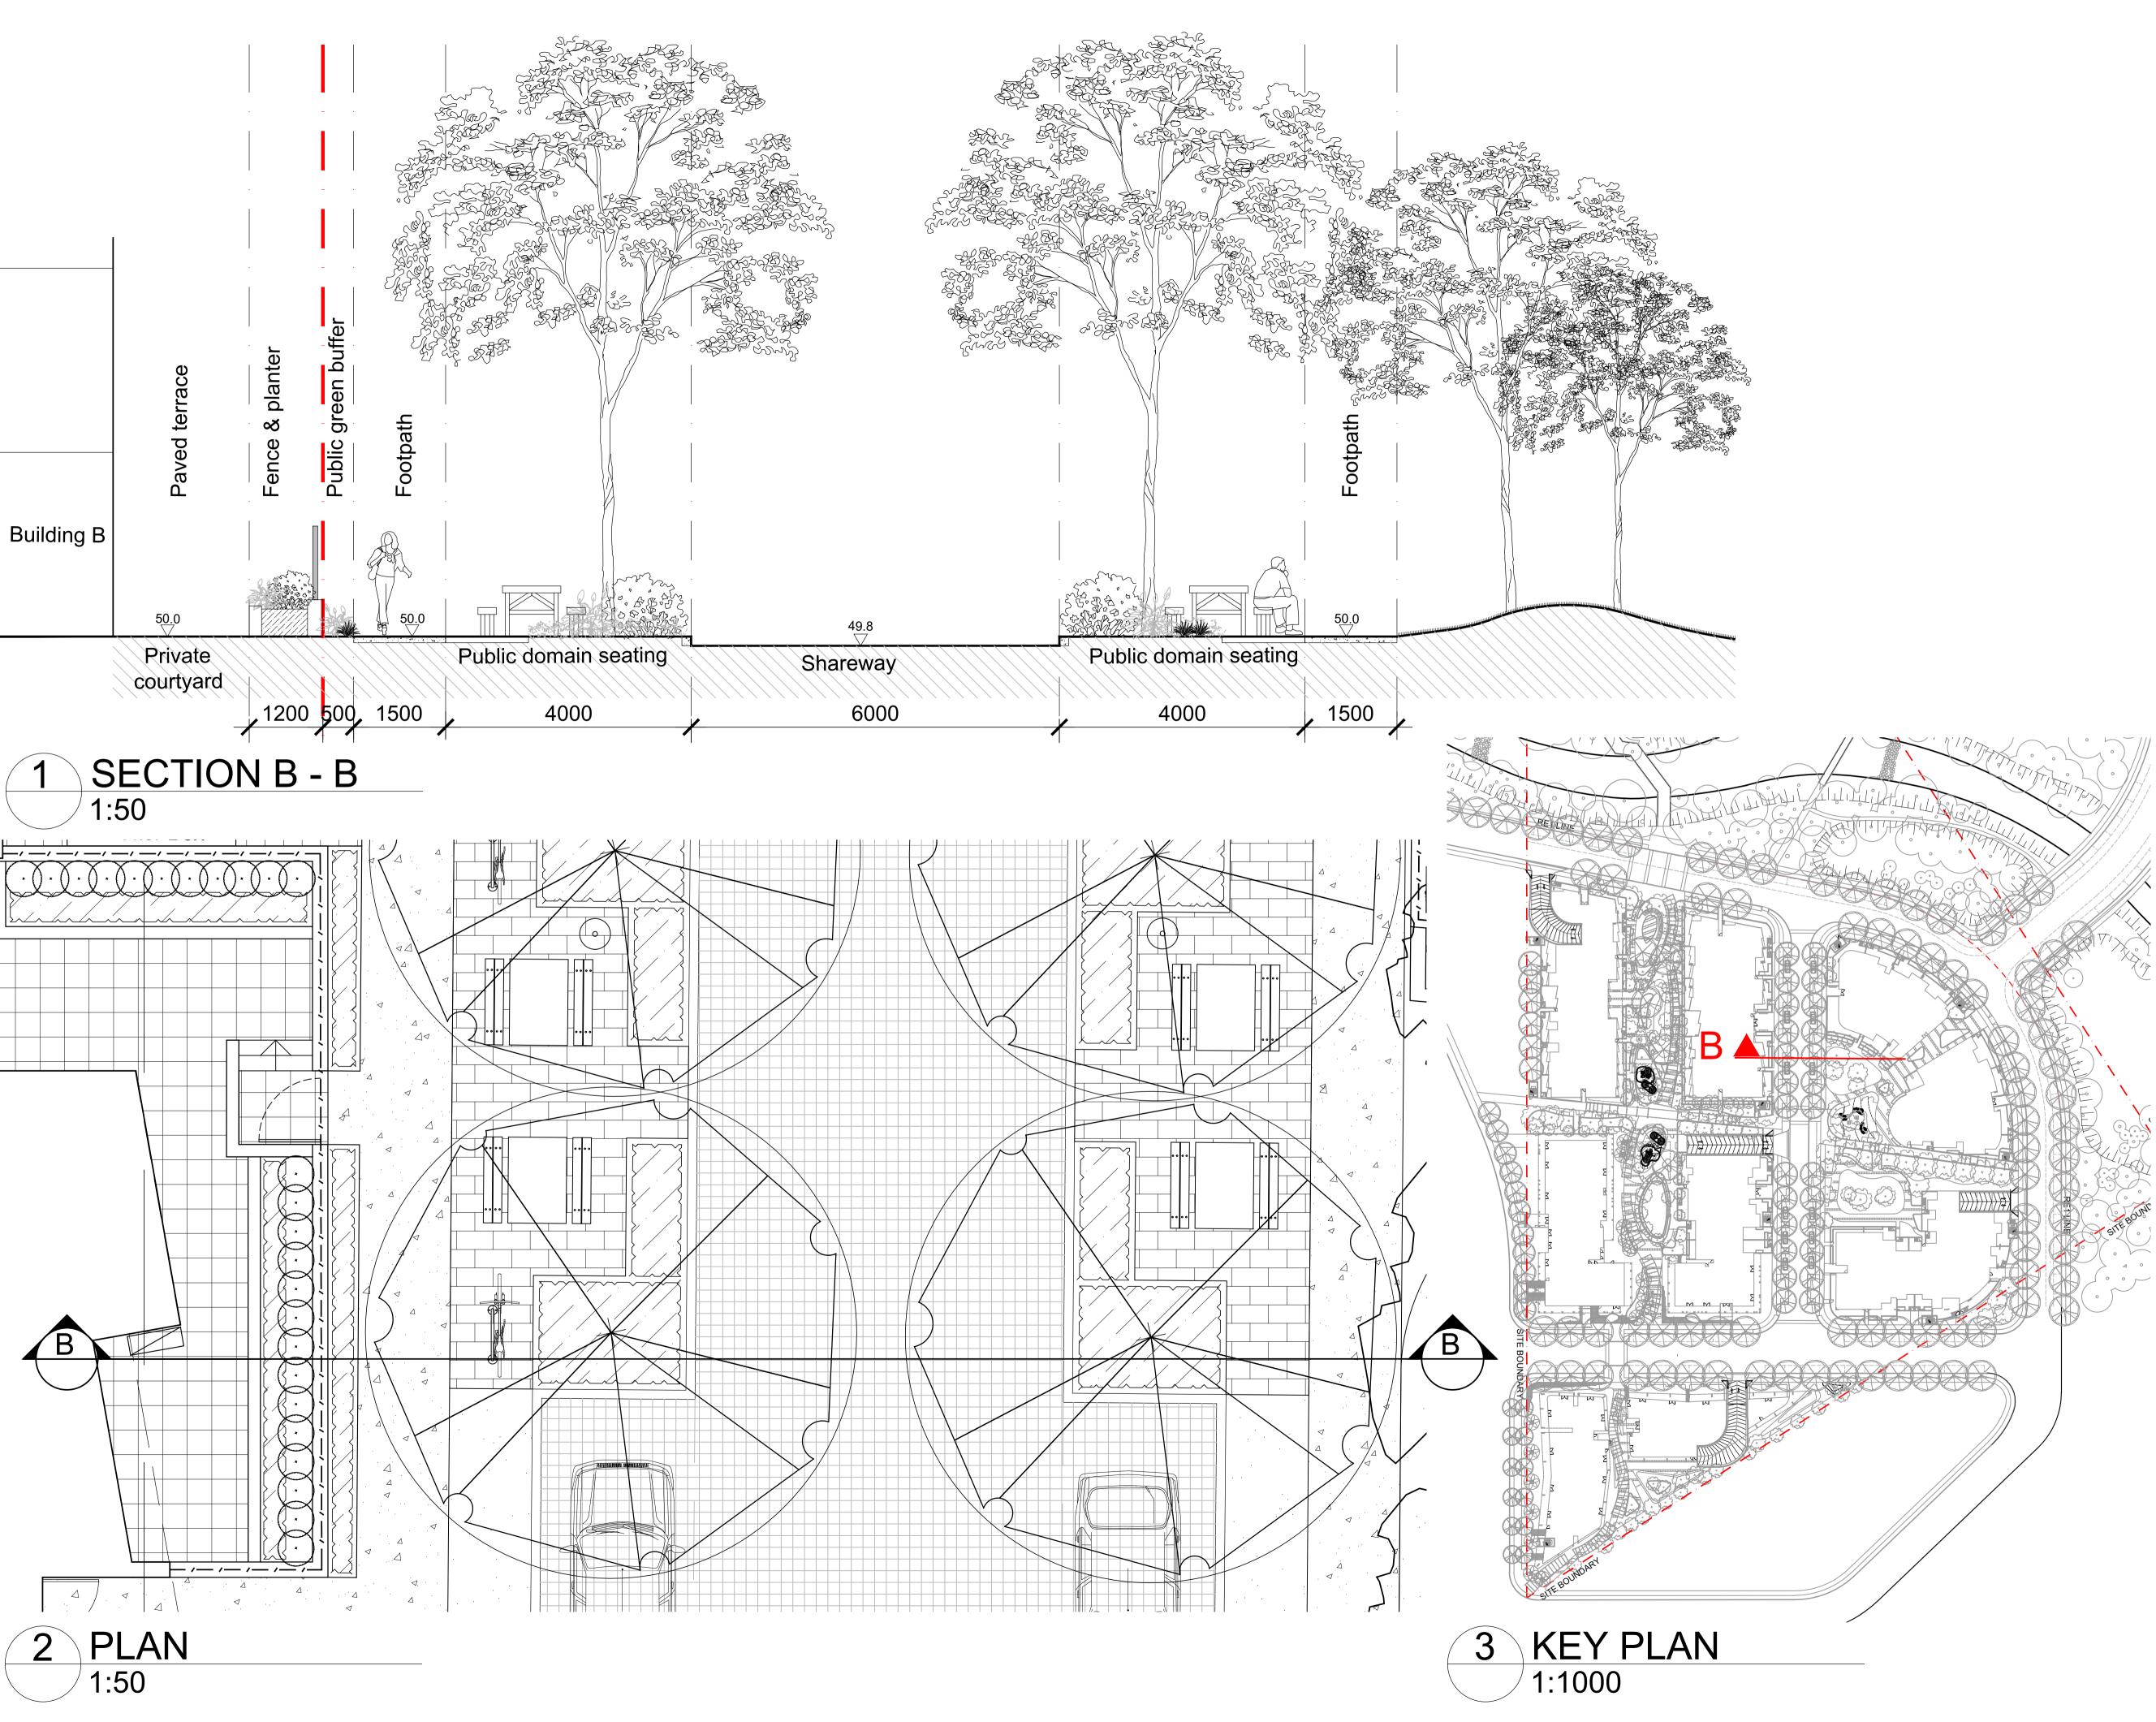
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601 C

Issue





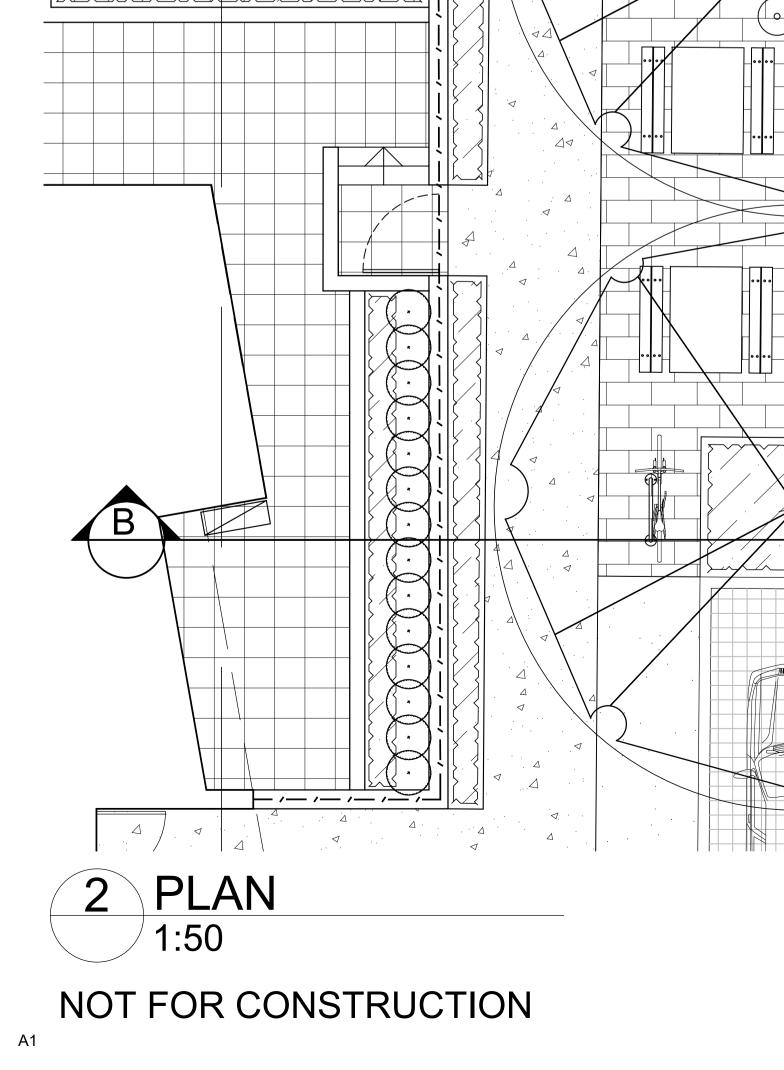

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C B	For Approval For Approval	PH PH		05.07.2021 11.06.2021
А	For Approval	PH	RS	27.05.2021
Issue	Revision Description	Drawn	Check	Date

LEGEND

Key Plan:

Superstar Holding Group P/L

Project:

EDMONDSON PARK 164 - 170 Croatia Ave Edmondson Park

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Drawing Numb


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Landscape Sections

Scale: As Shown Job Number:

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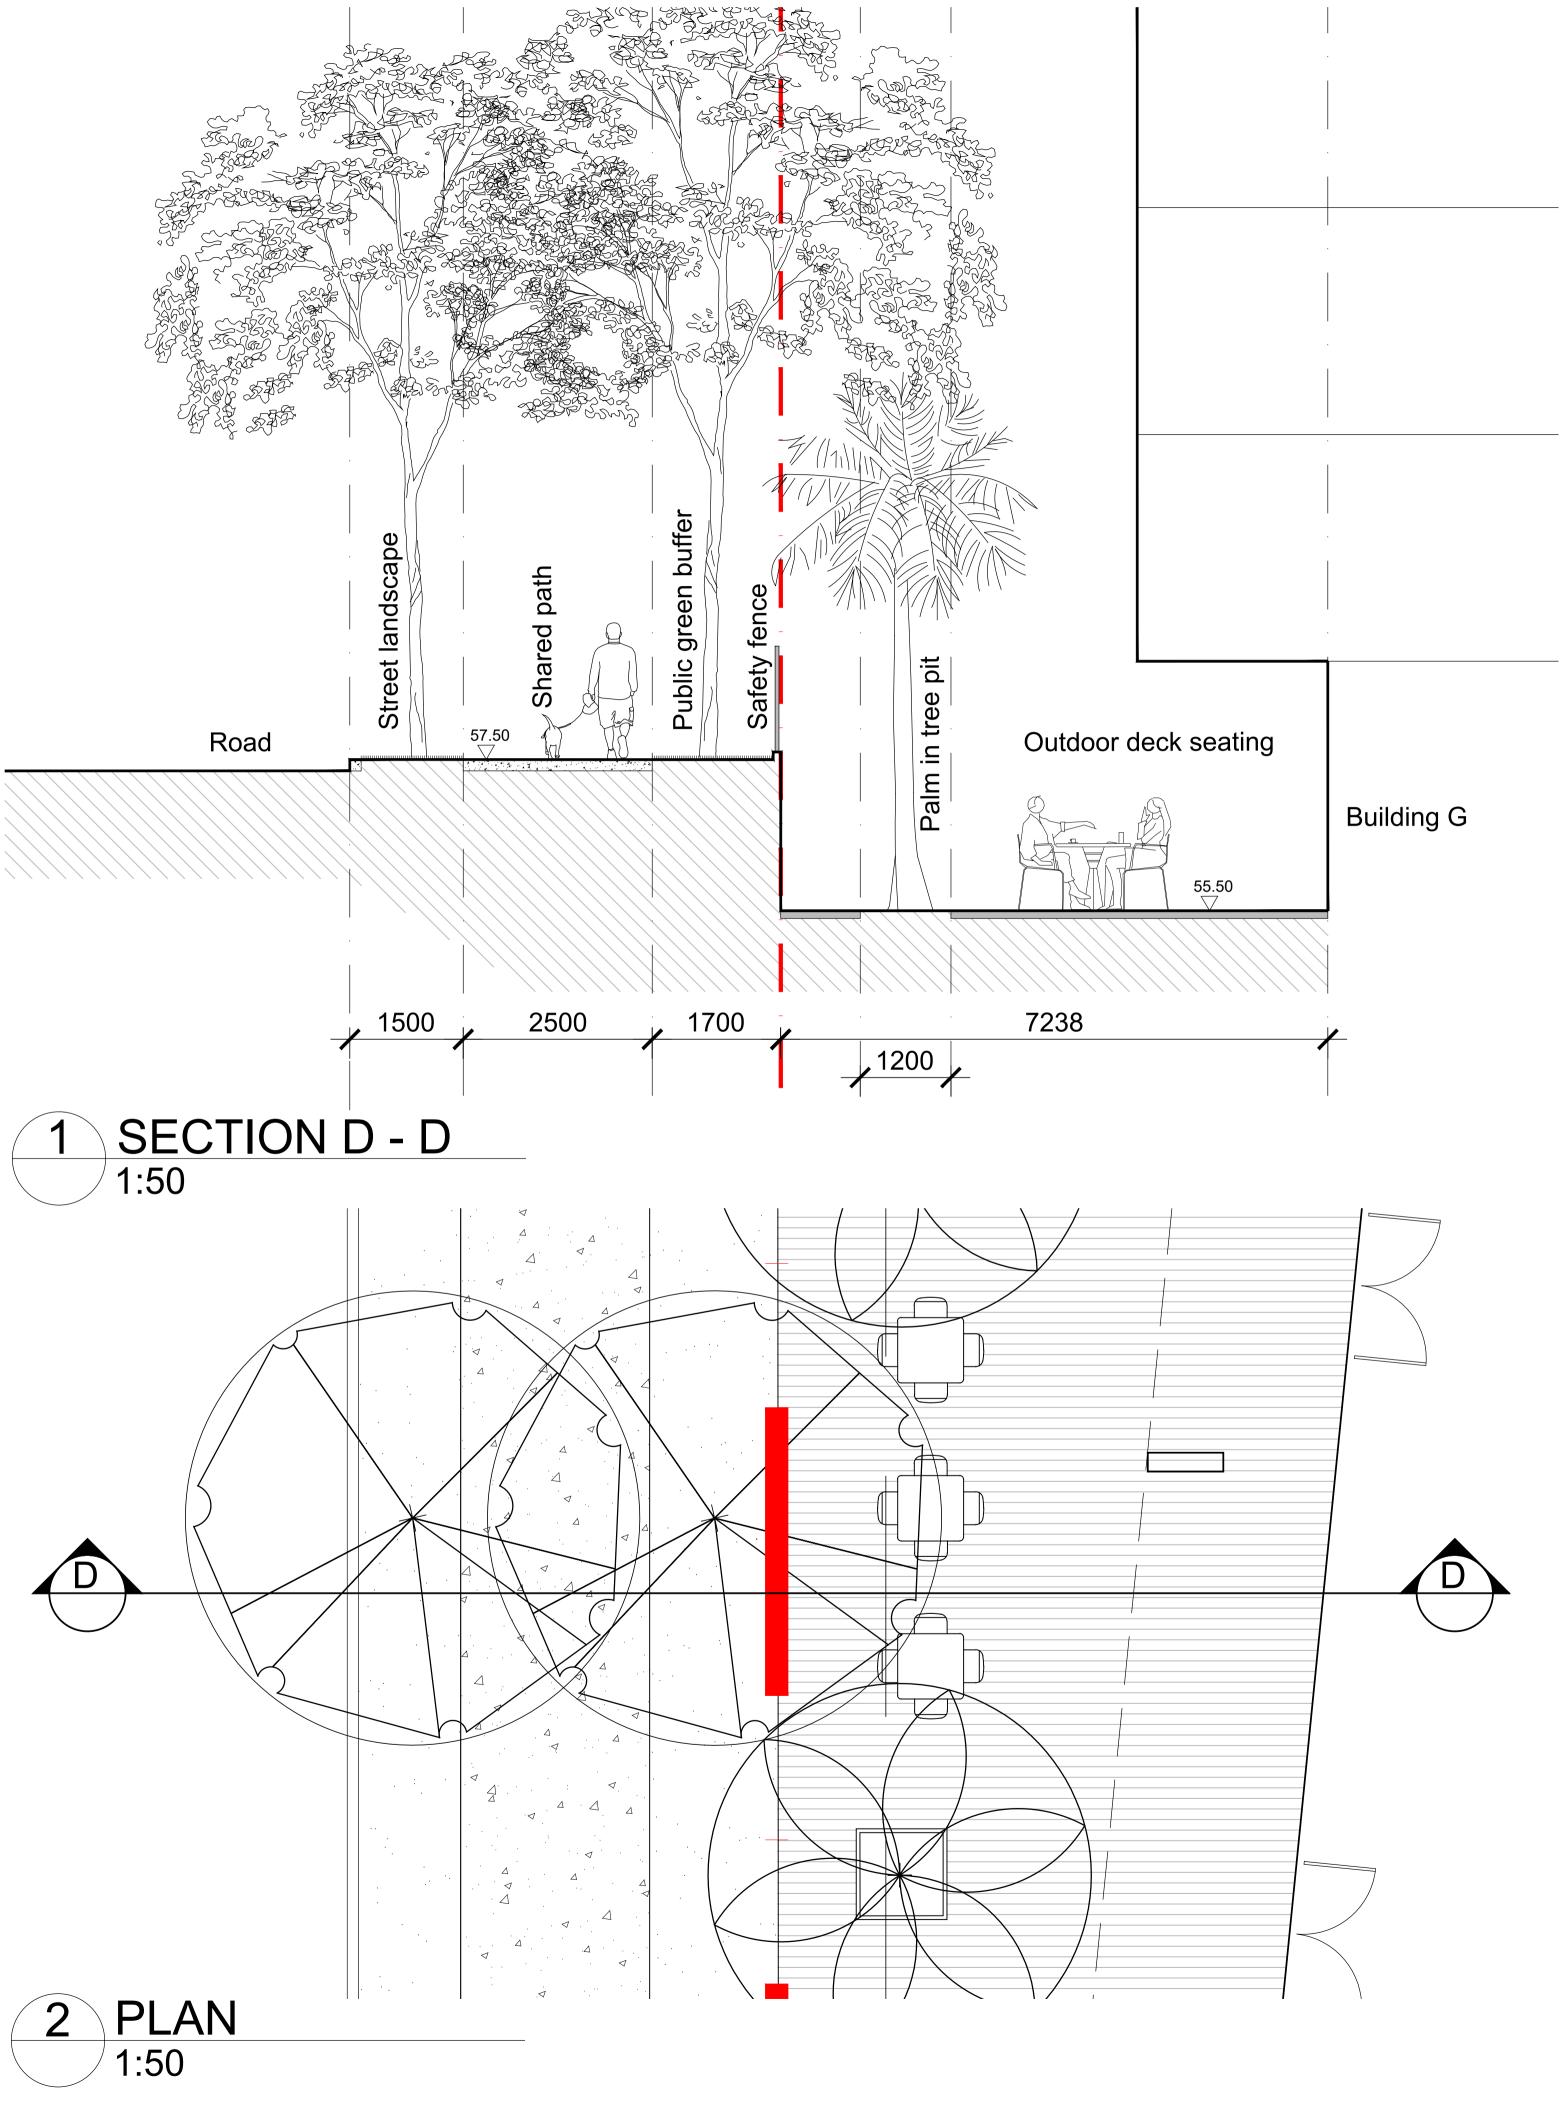
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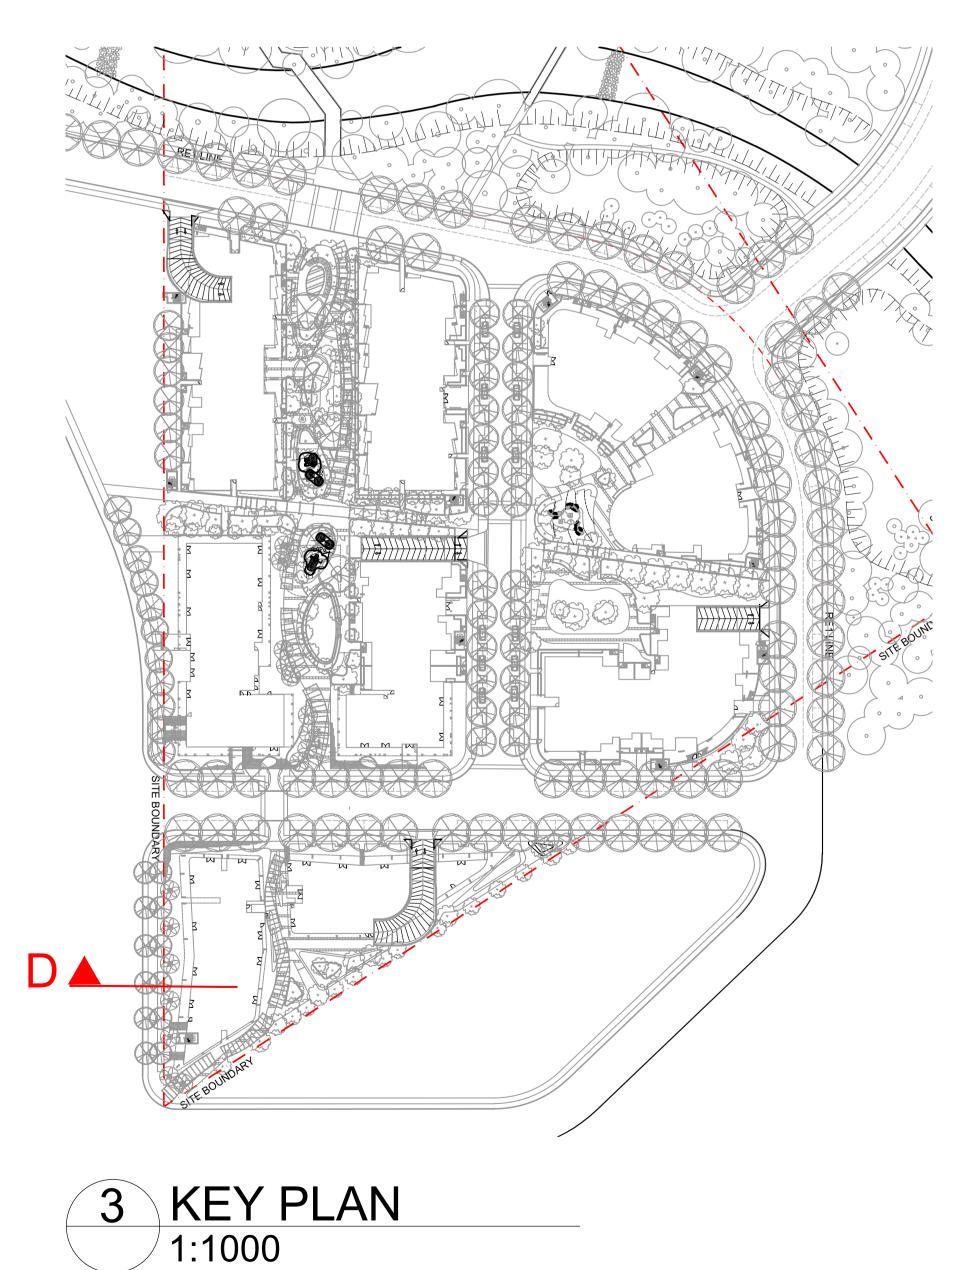


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Sheet _ of _



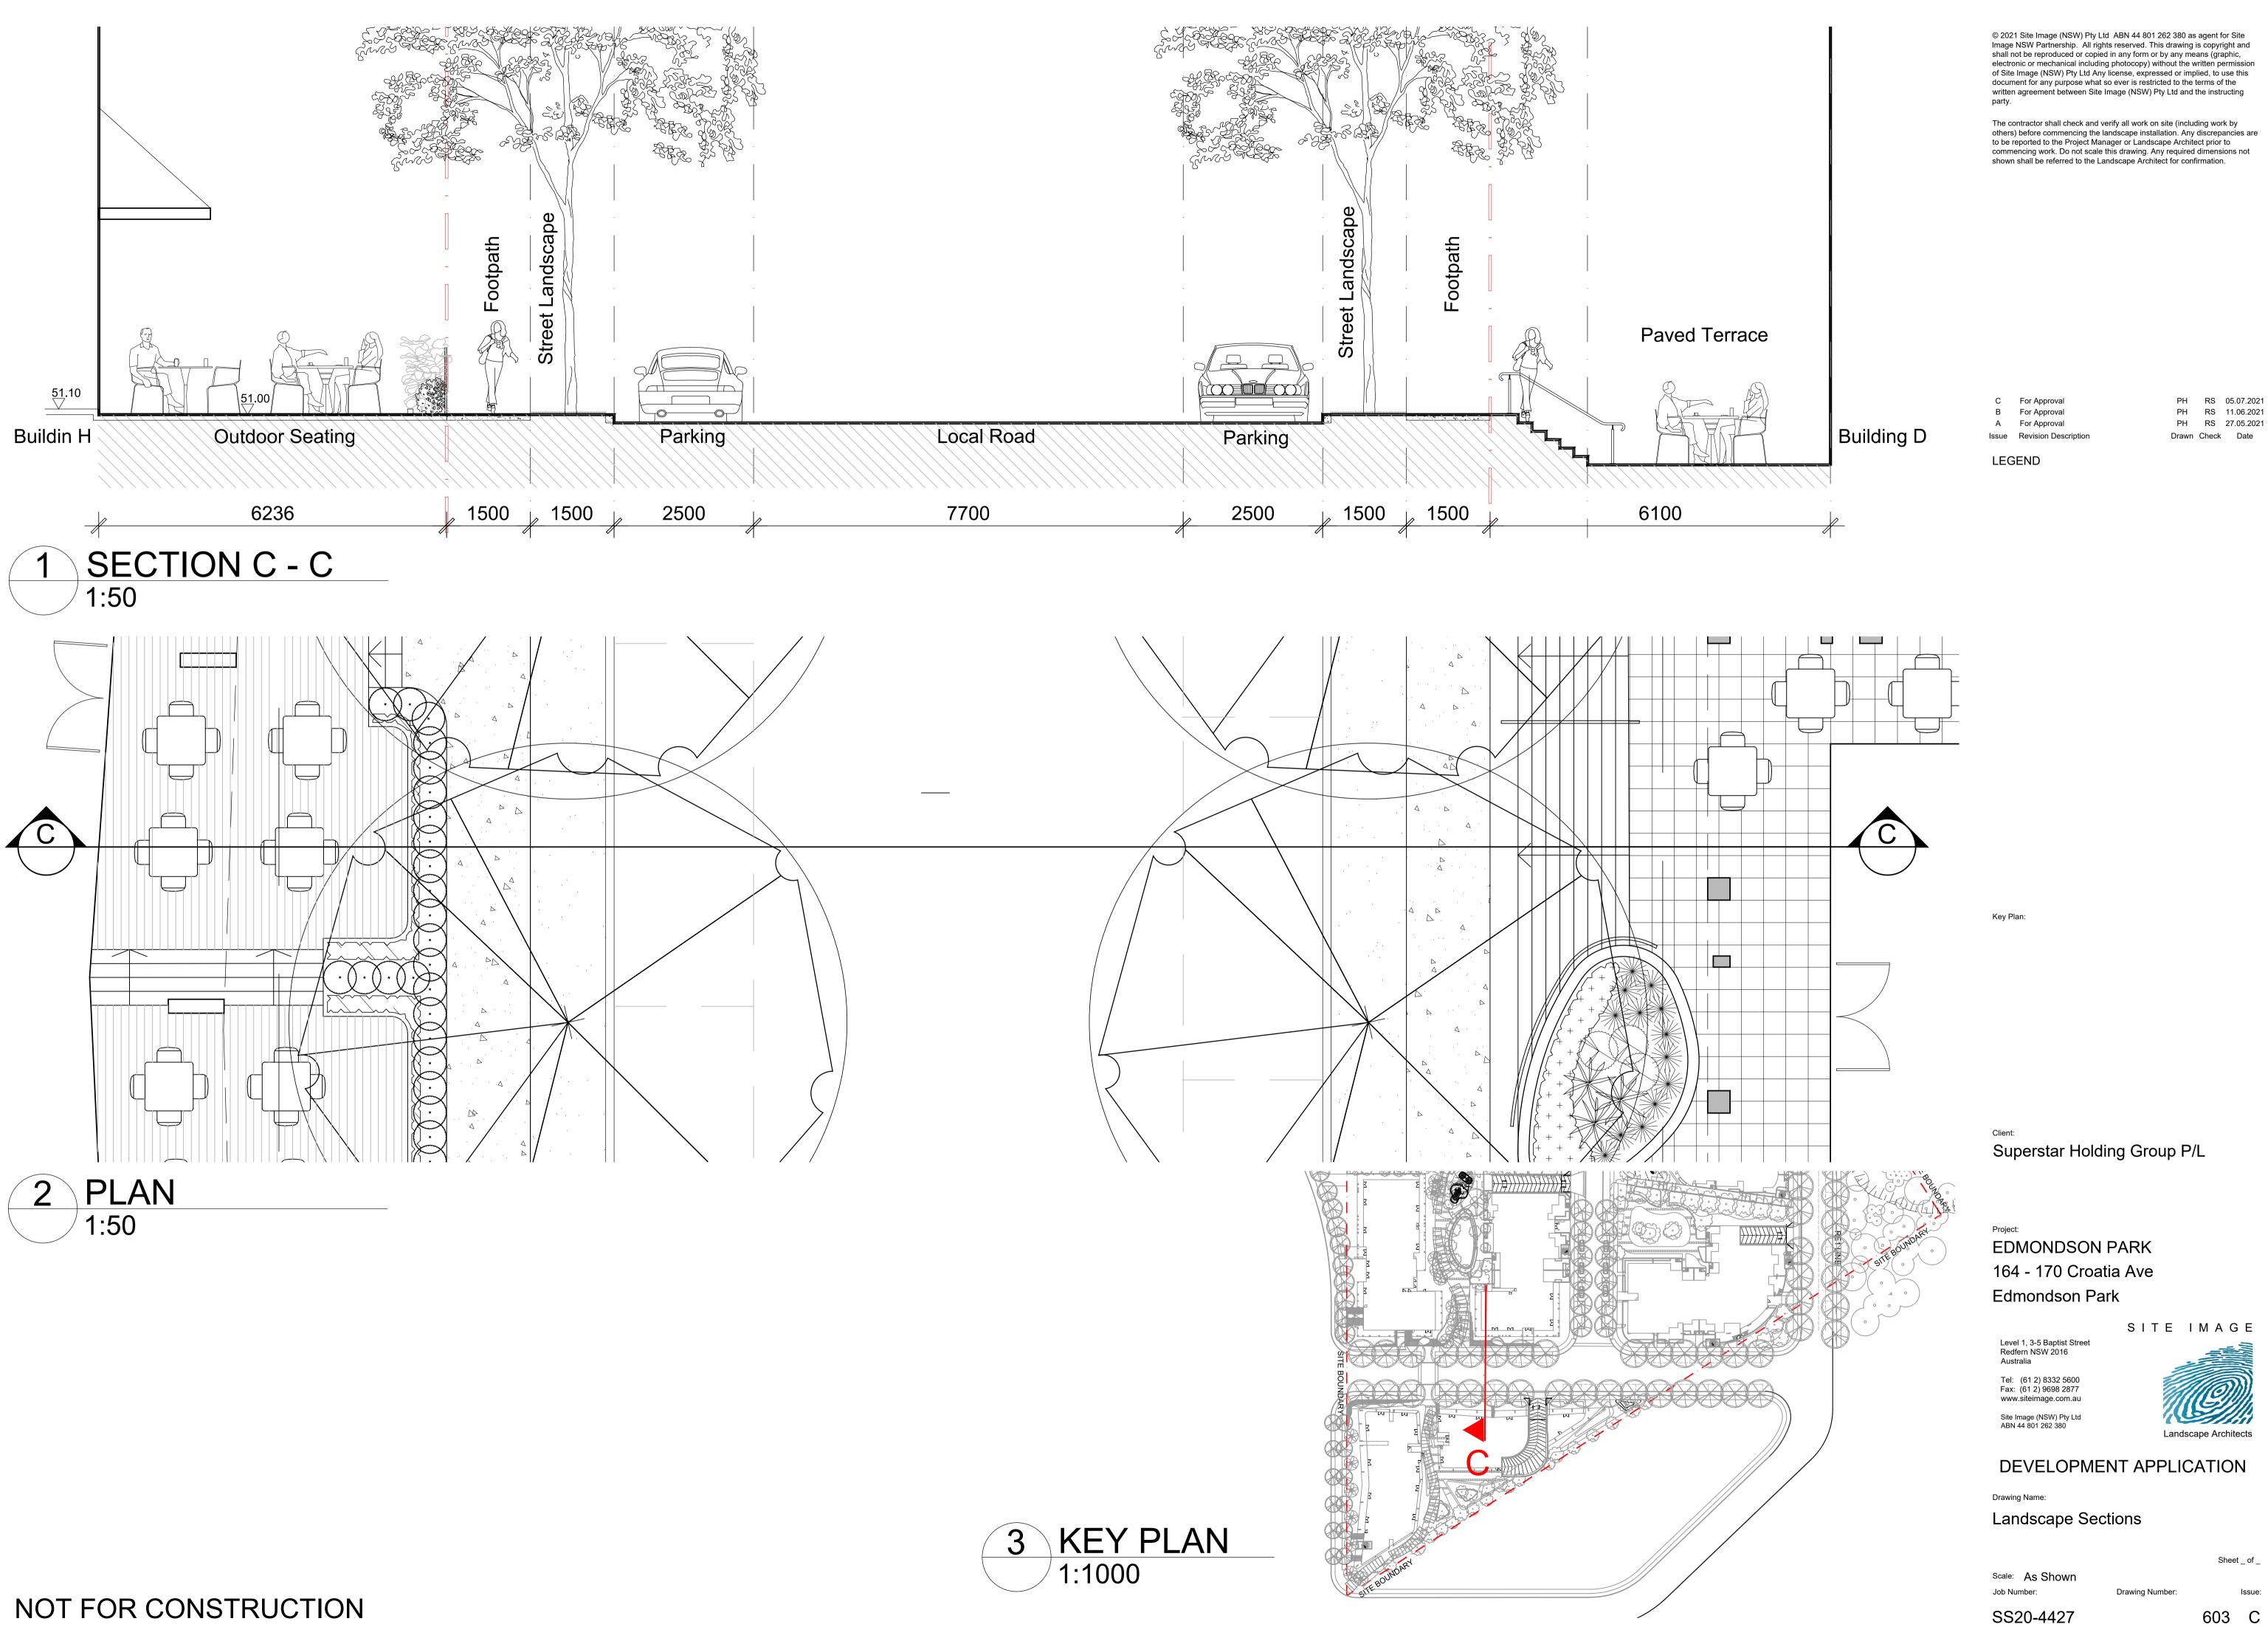

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С	For Approval	PH		
B A	For Approval For Approval	PH PH		11.06.2021 27.05.2021
Issue	Revision Description	Drawn	Check	Date

LEGEND

Key Plan:

Superstar Holding Group P/L

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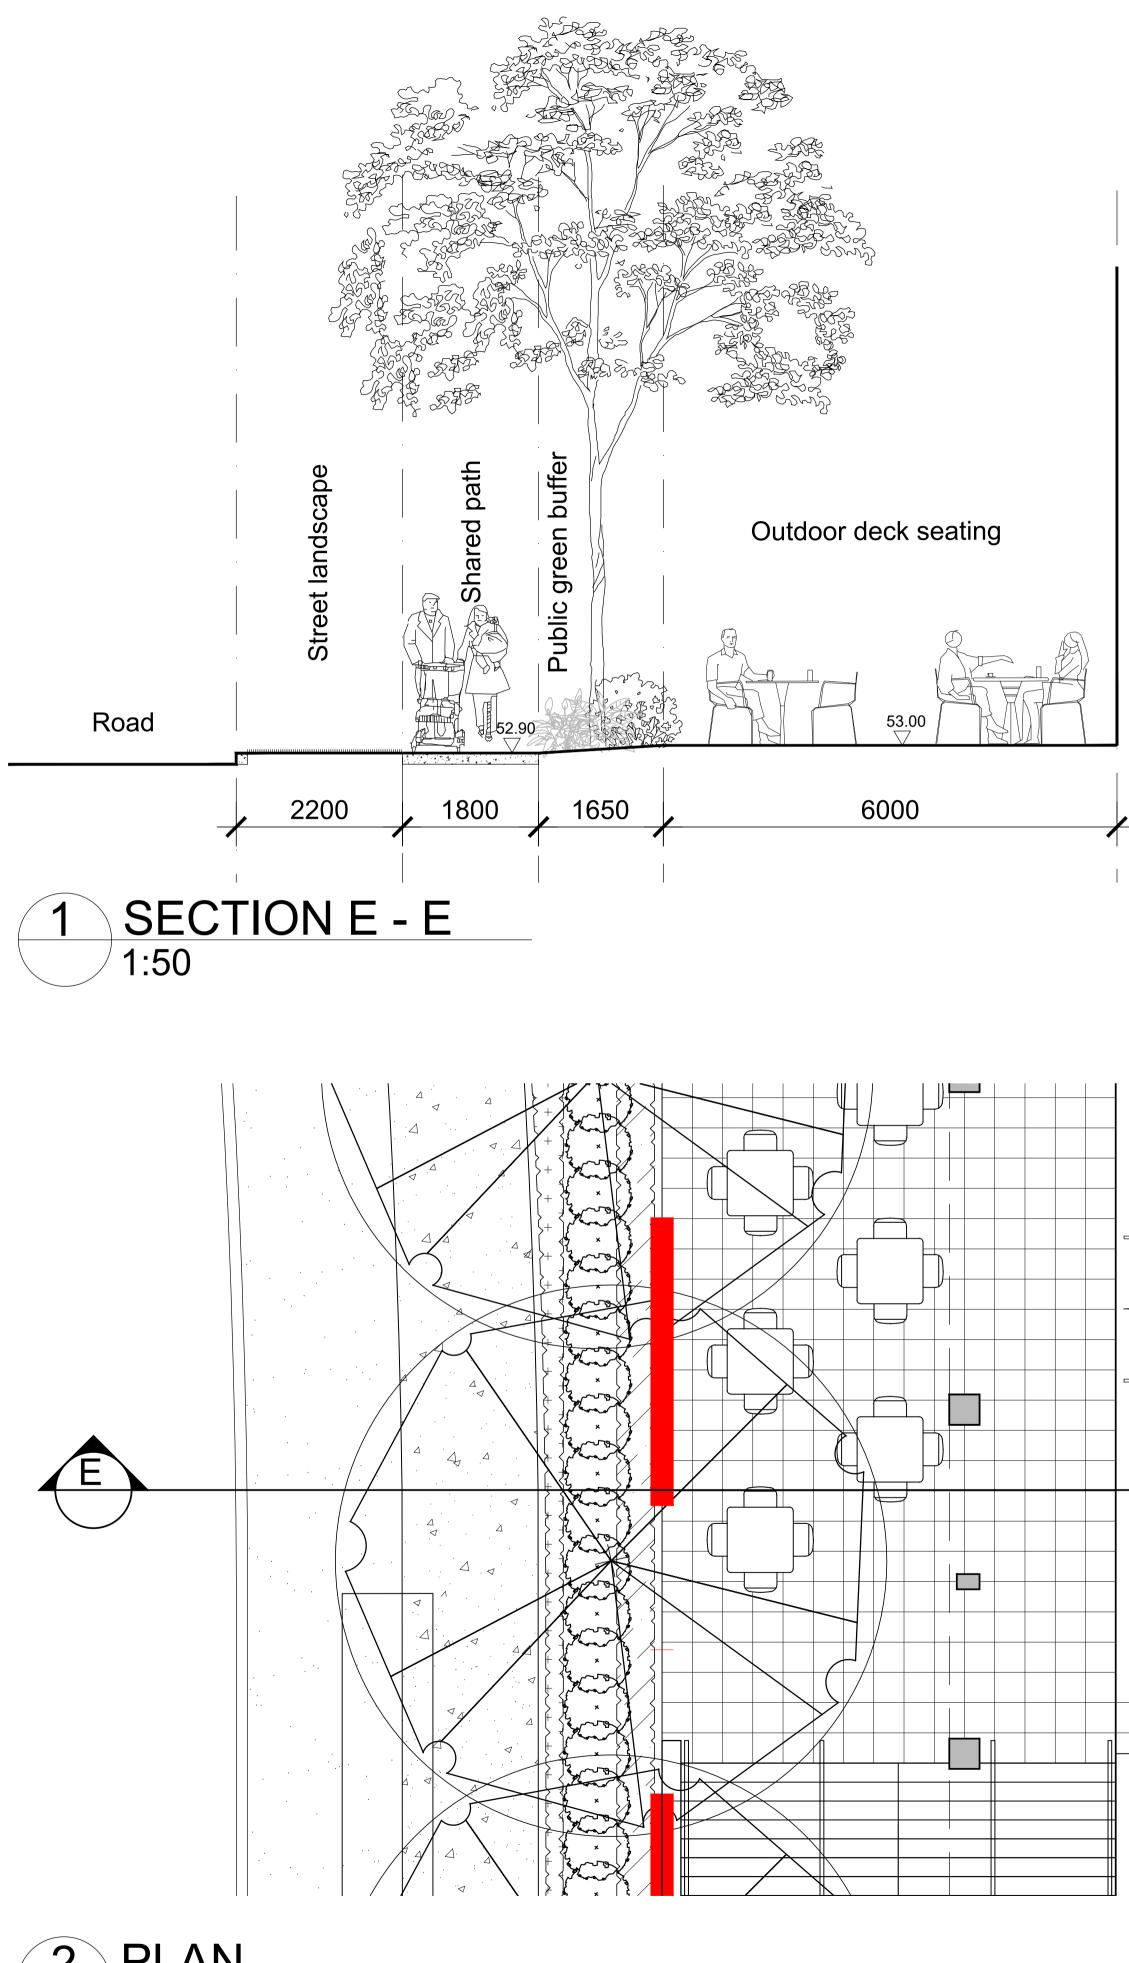
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Landscape Sections

Scale: As Shown Job Number:

Sheet _ of _


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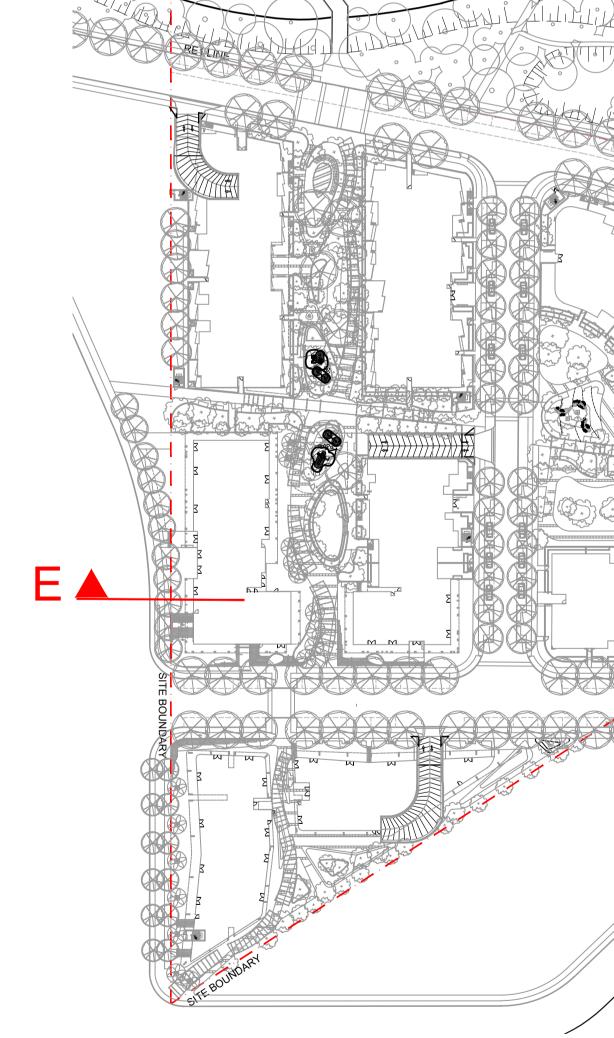




Building C

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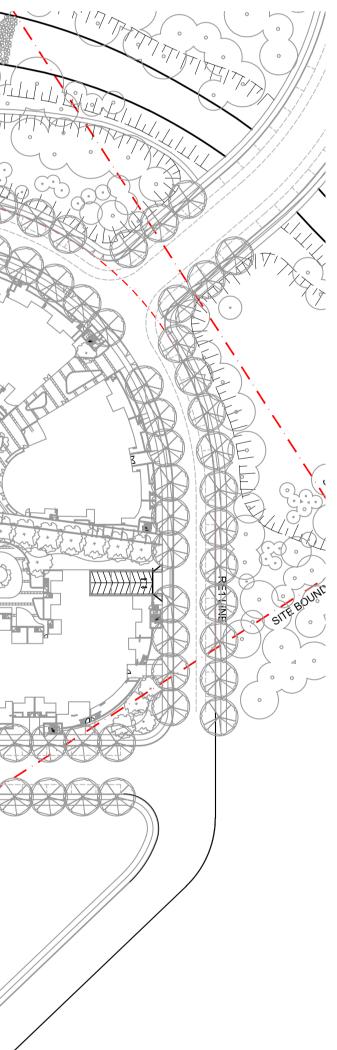


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А	For Approval	PH	RS	27.05.2021
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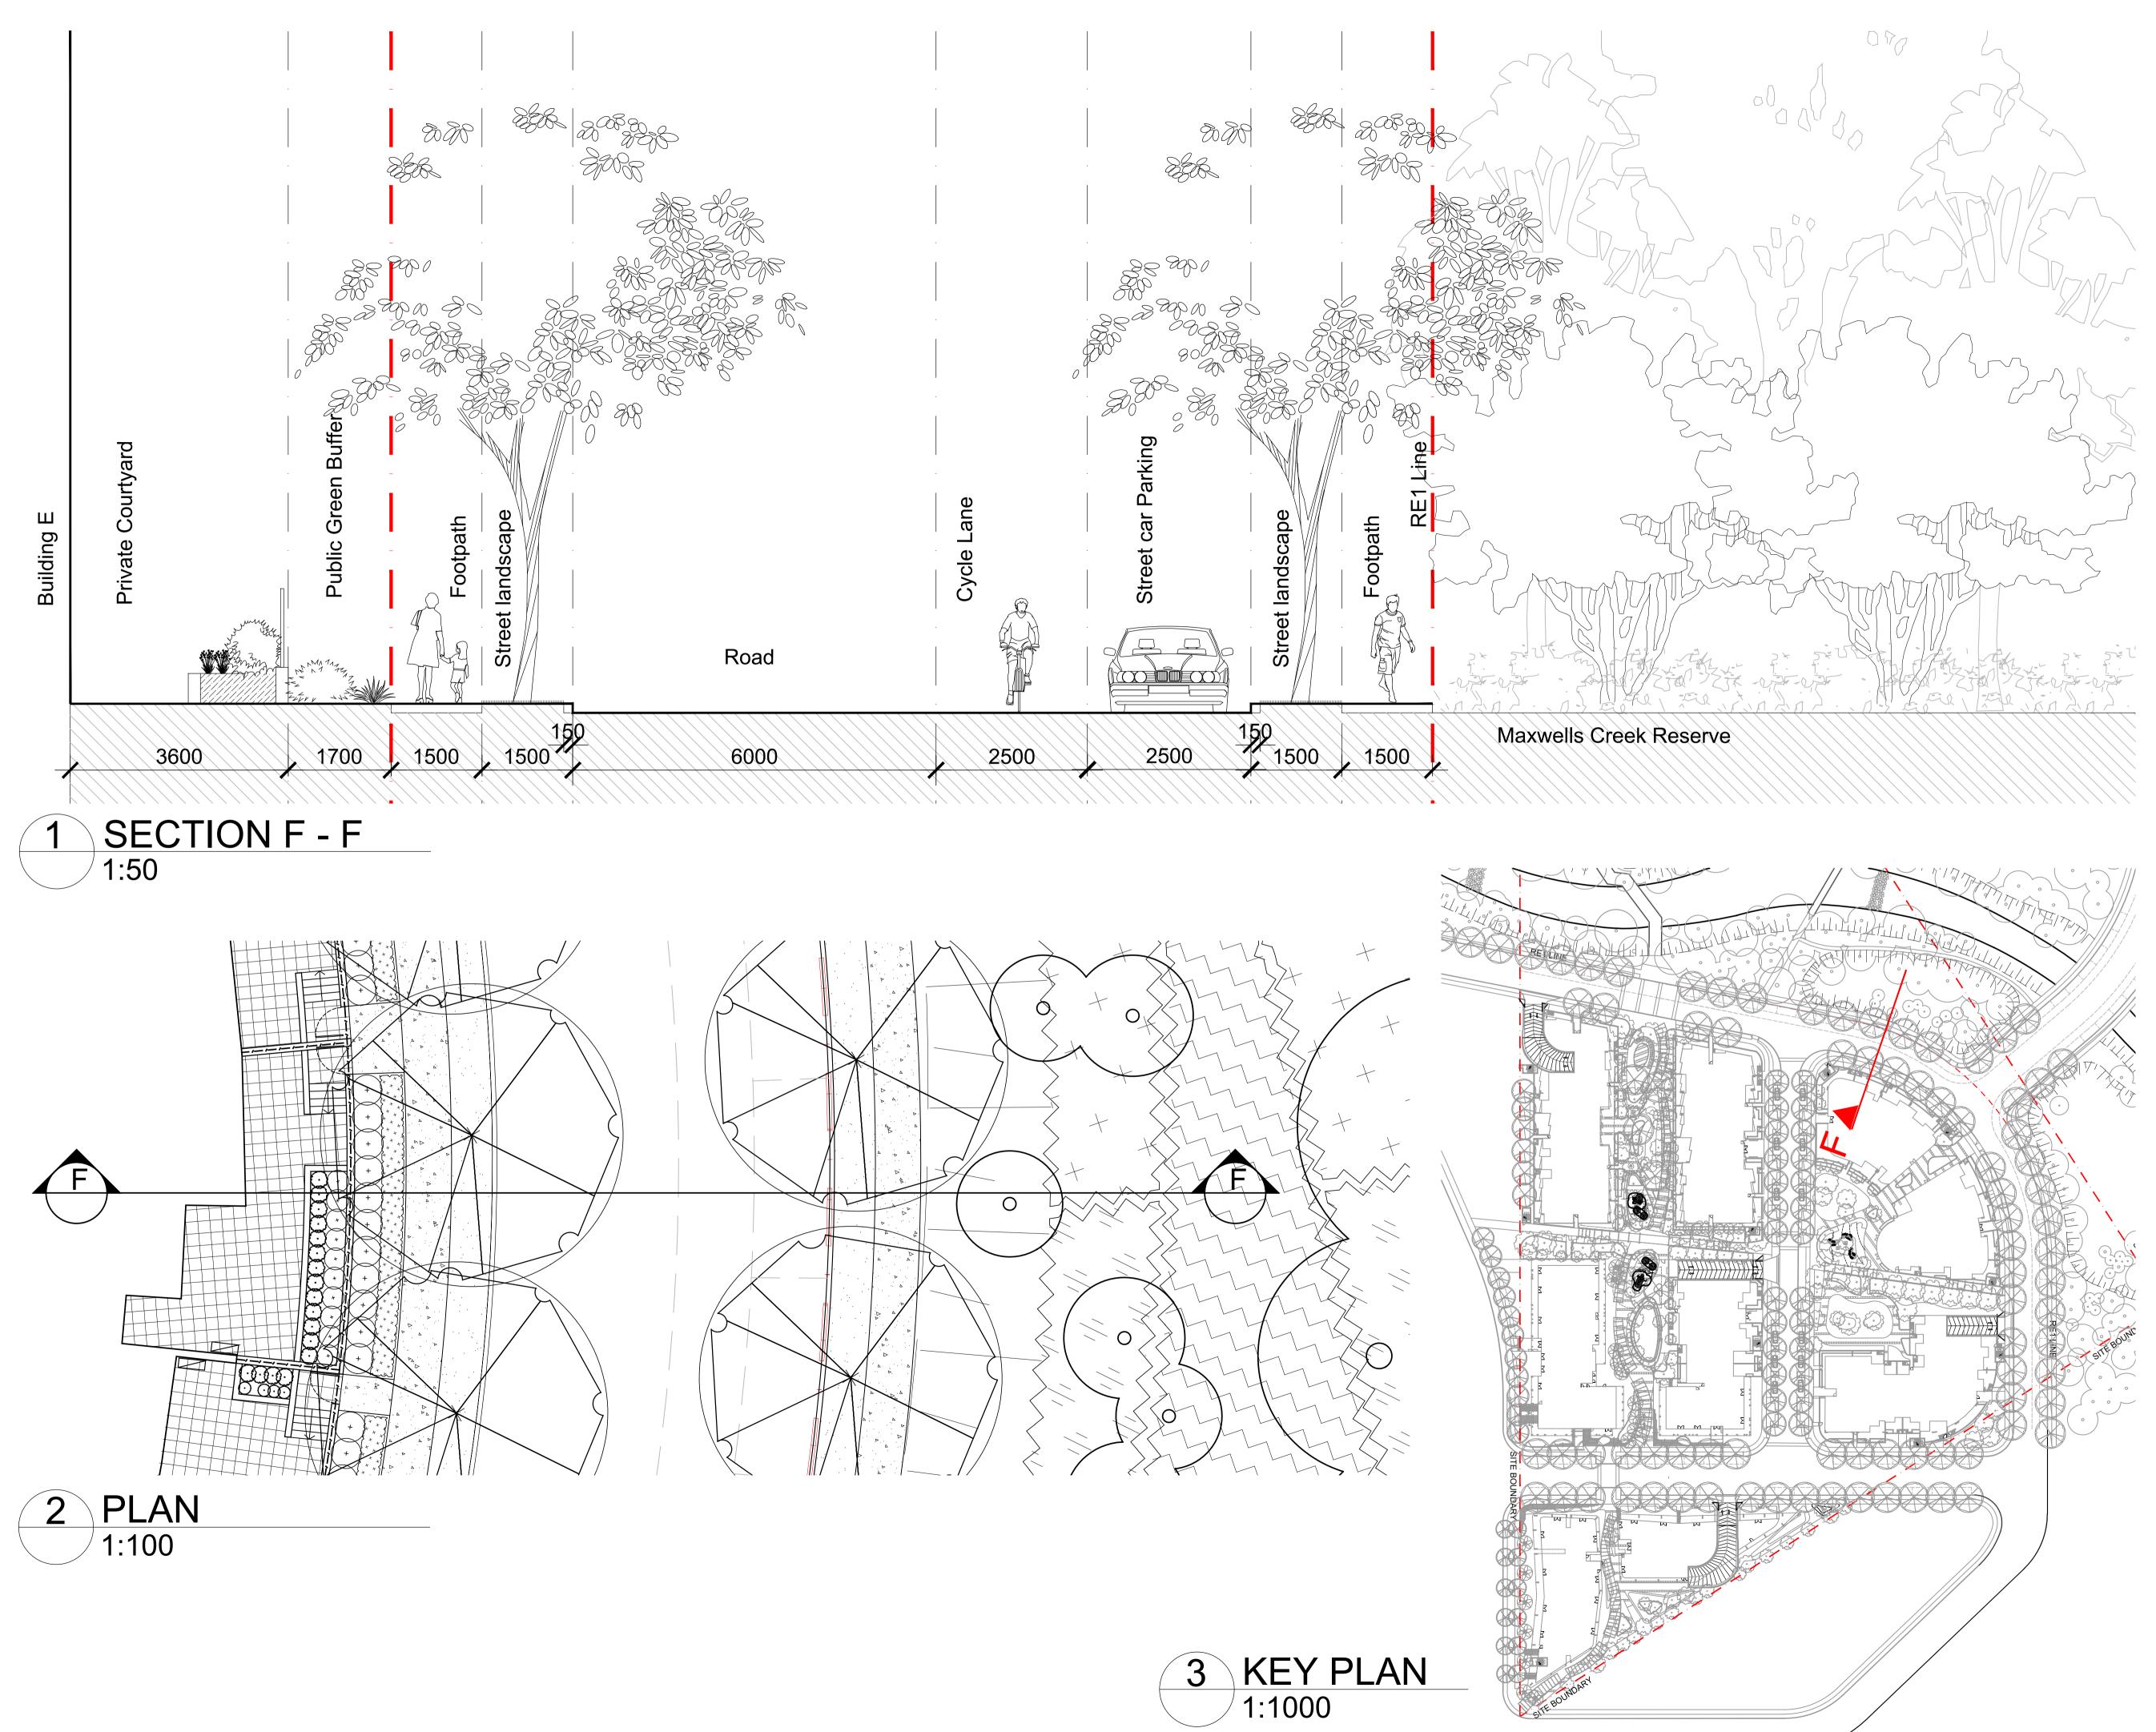
Drawing Name:

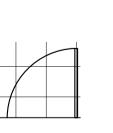Landscape Sections

Scale: As Shown Job Number:

Sheet _ of _

SS20-4427



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Issue	Revision Description	Drawn	Check	Date

LEGEND

Key Plan:

Client: Superstar Holding Group P/L

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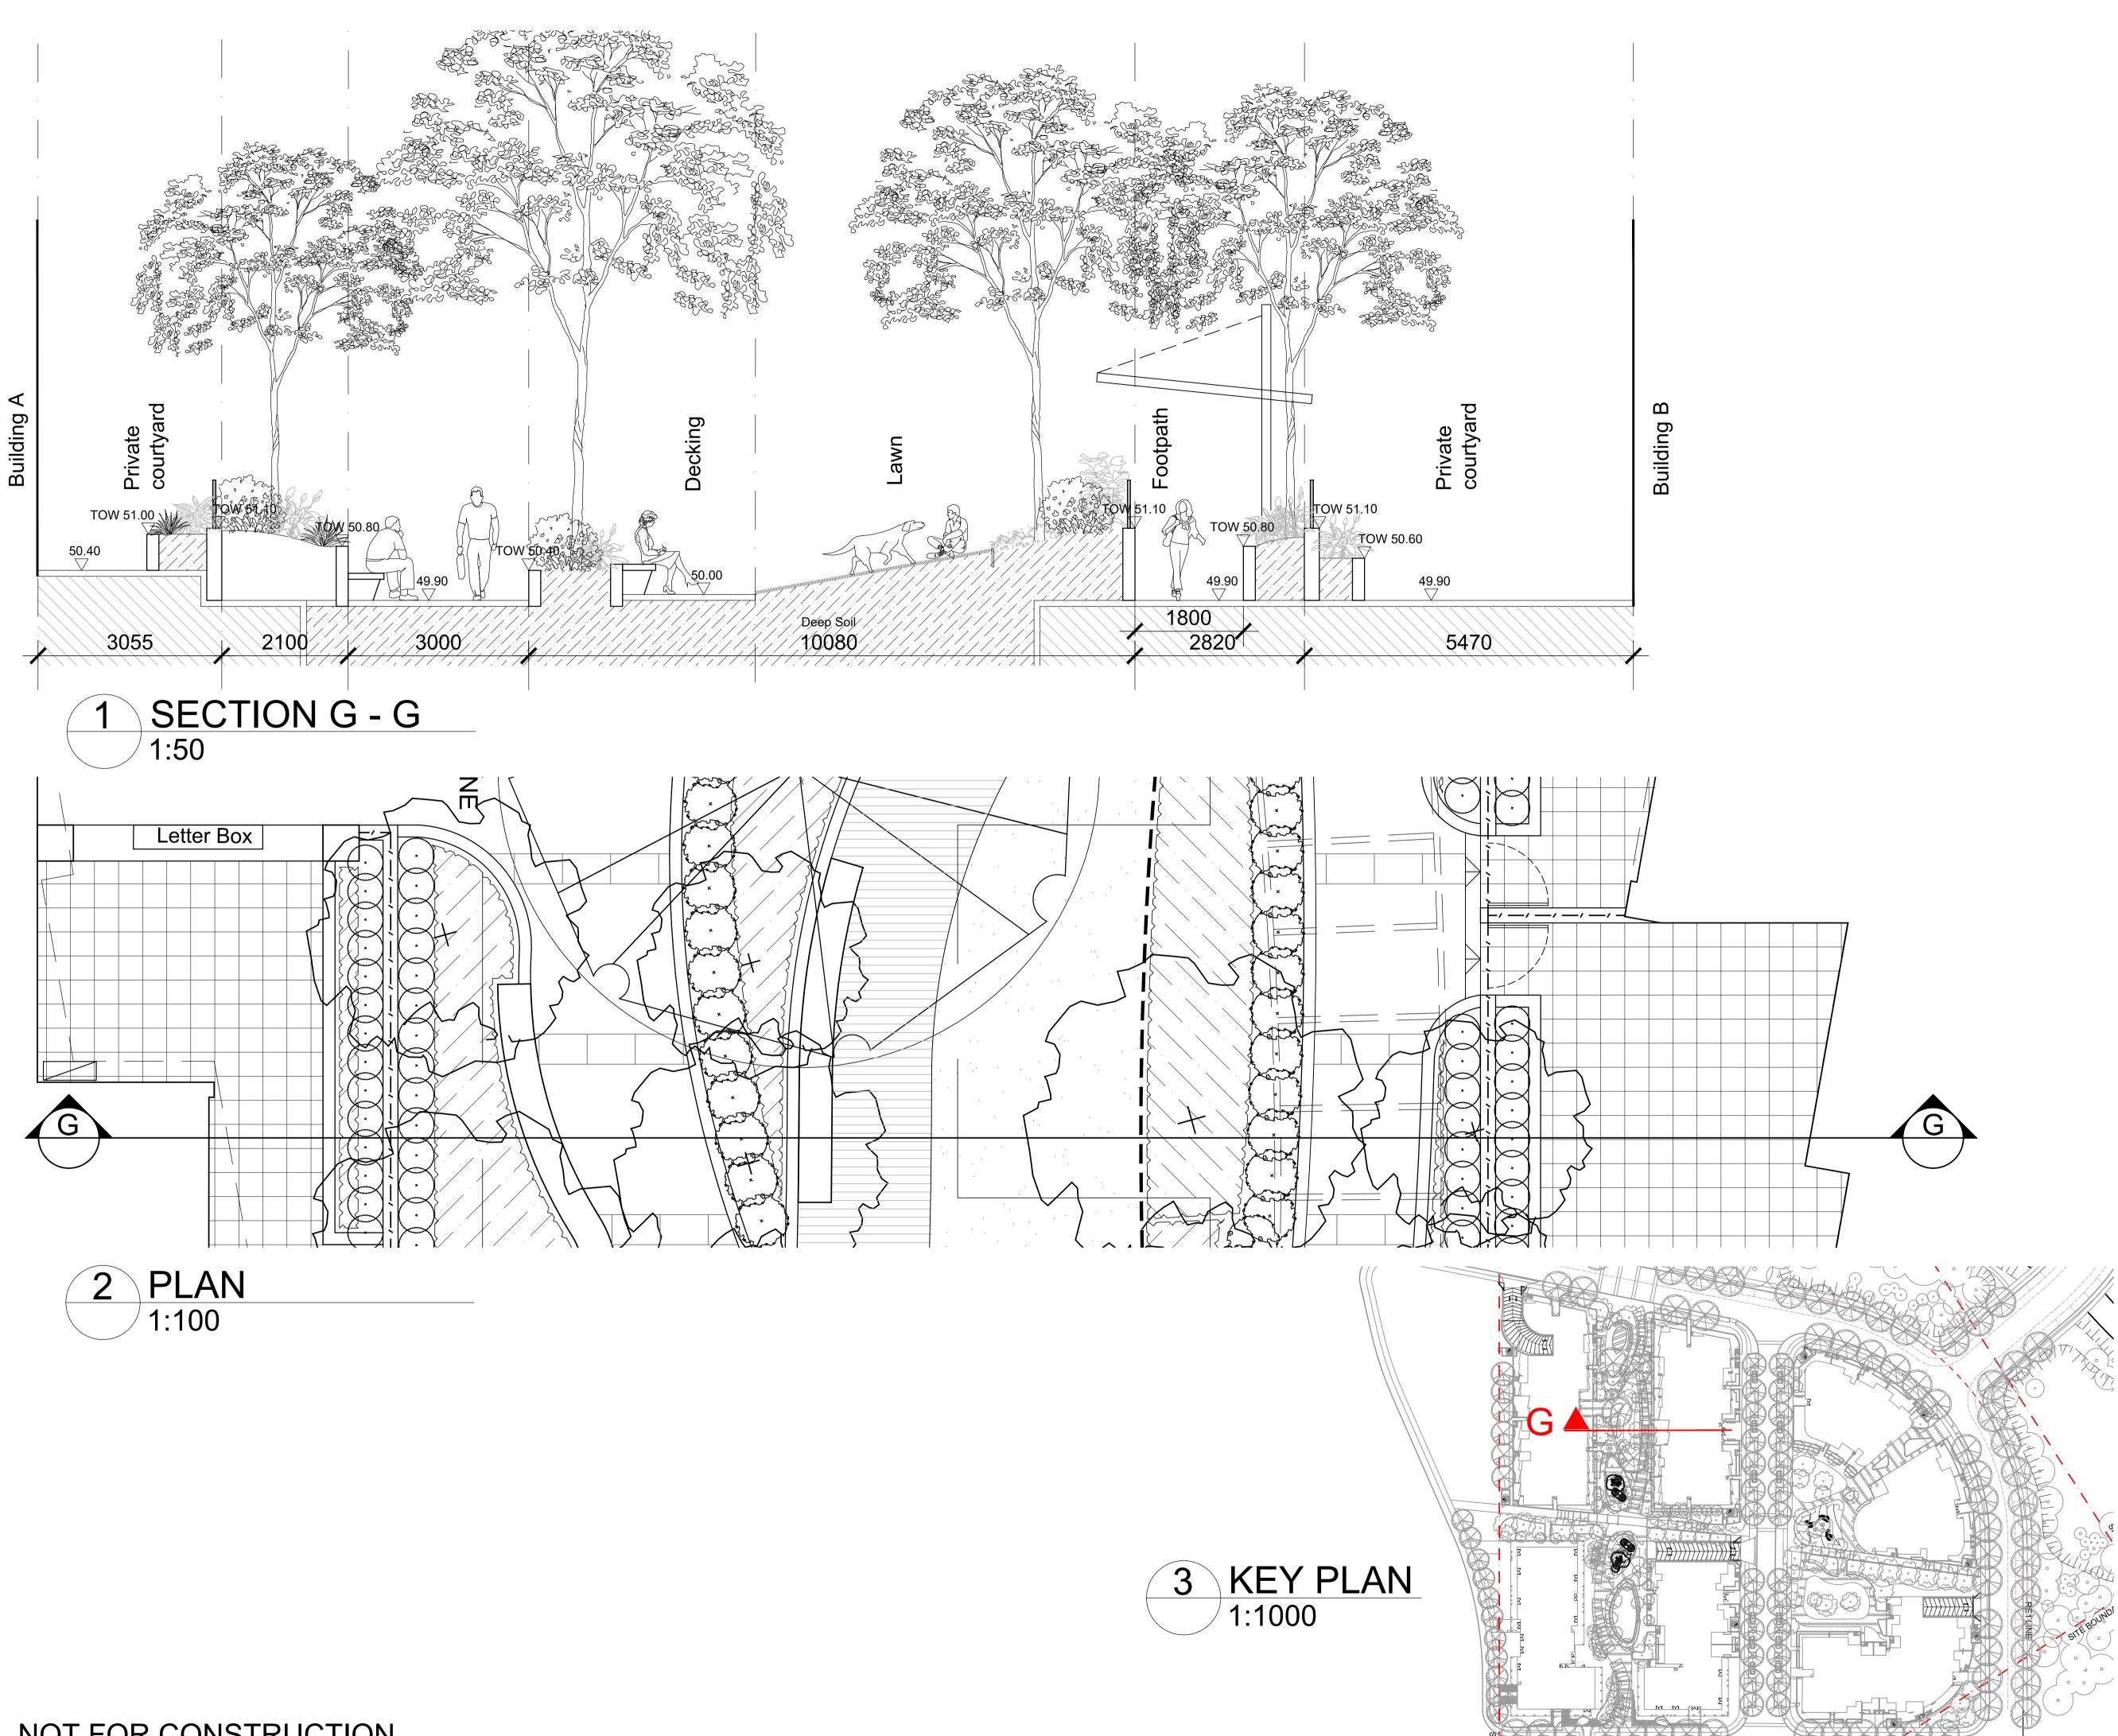


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Drawing Name:

Landscape Sections

Scale: As Shown Job Number: Sheet _ of _



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A	For Approval	PH		27.05.2021
Issue	Revision Description	Drawn	Check	Date

LEGEND



Key Plan:

Client: Superstar Holding Group P/L

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Drawing Name:


Australia

Landscape Sections

Scale: As Shown Job Number:

Sheet _ of _

SS20-4427

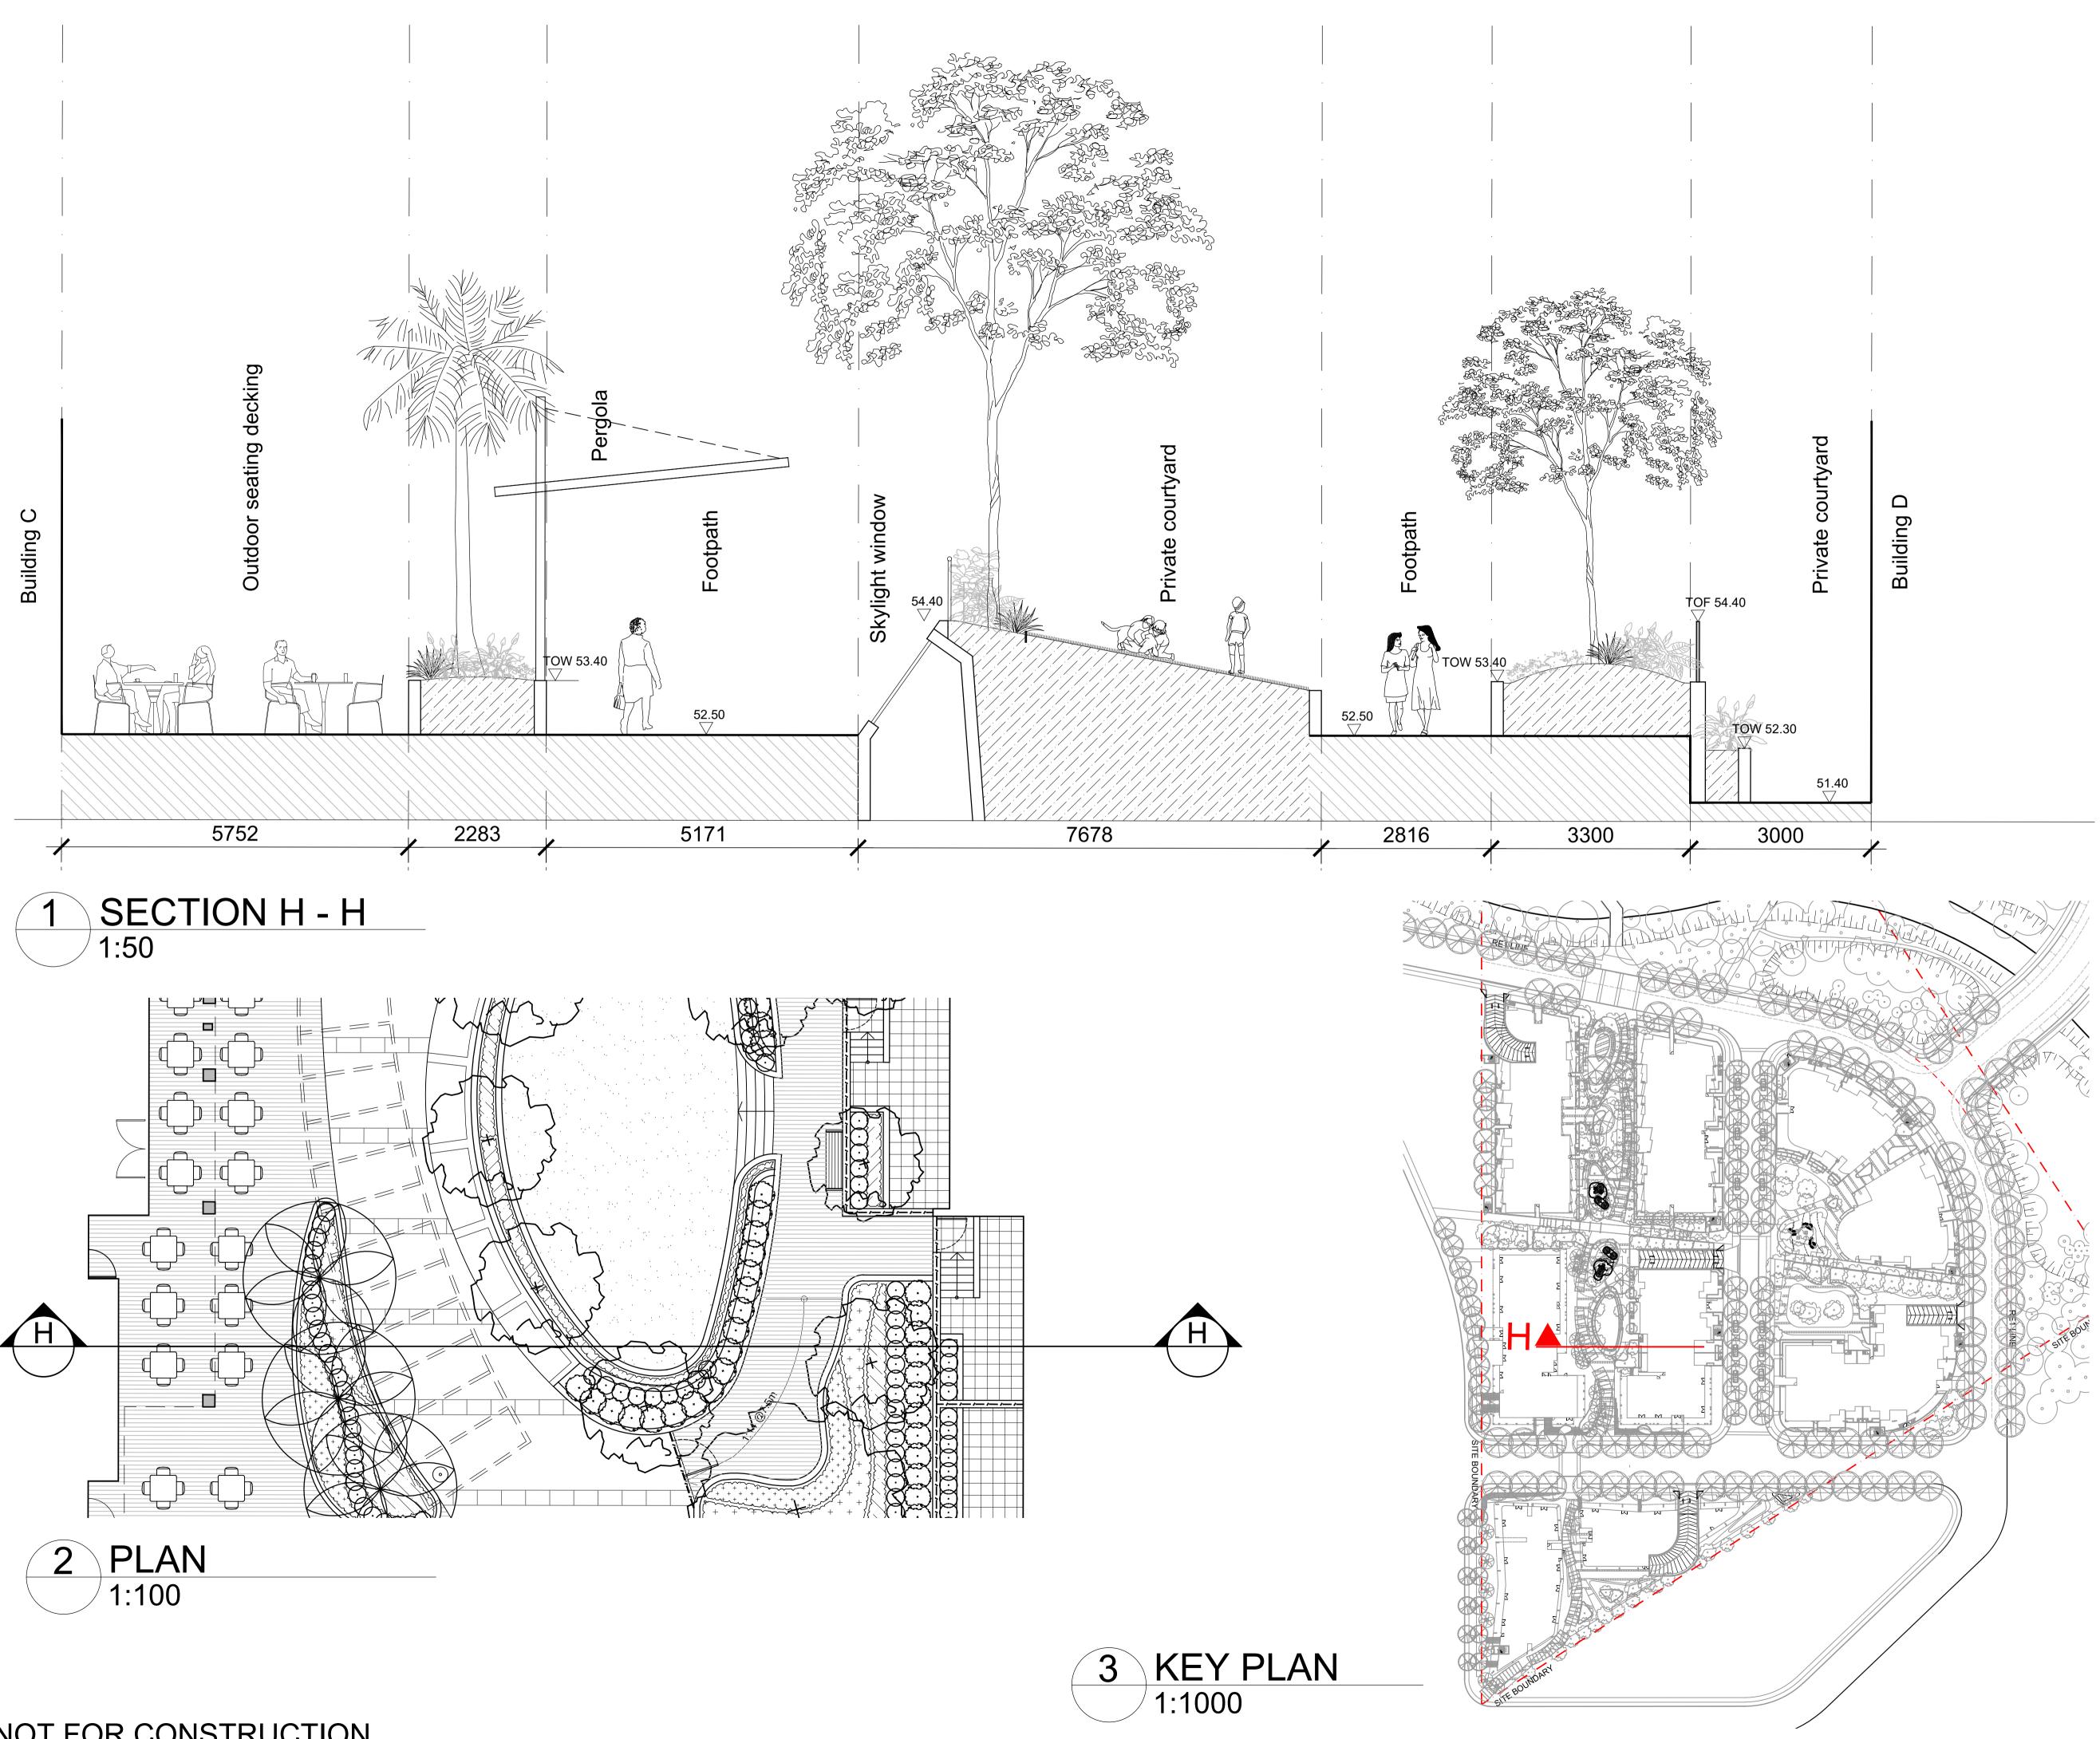

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Superstar Holding Group P/L

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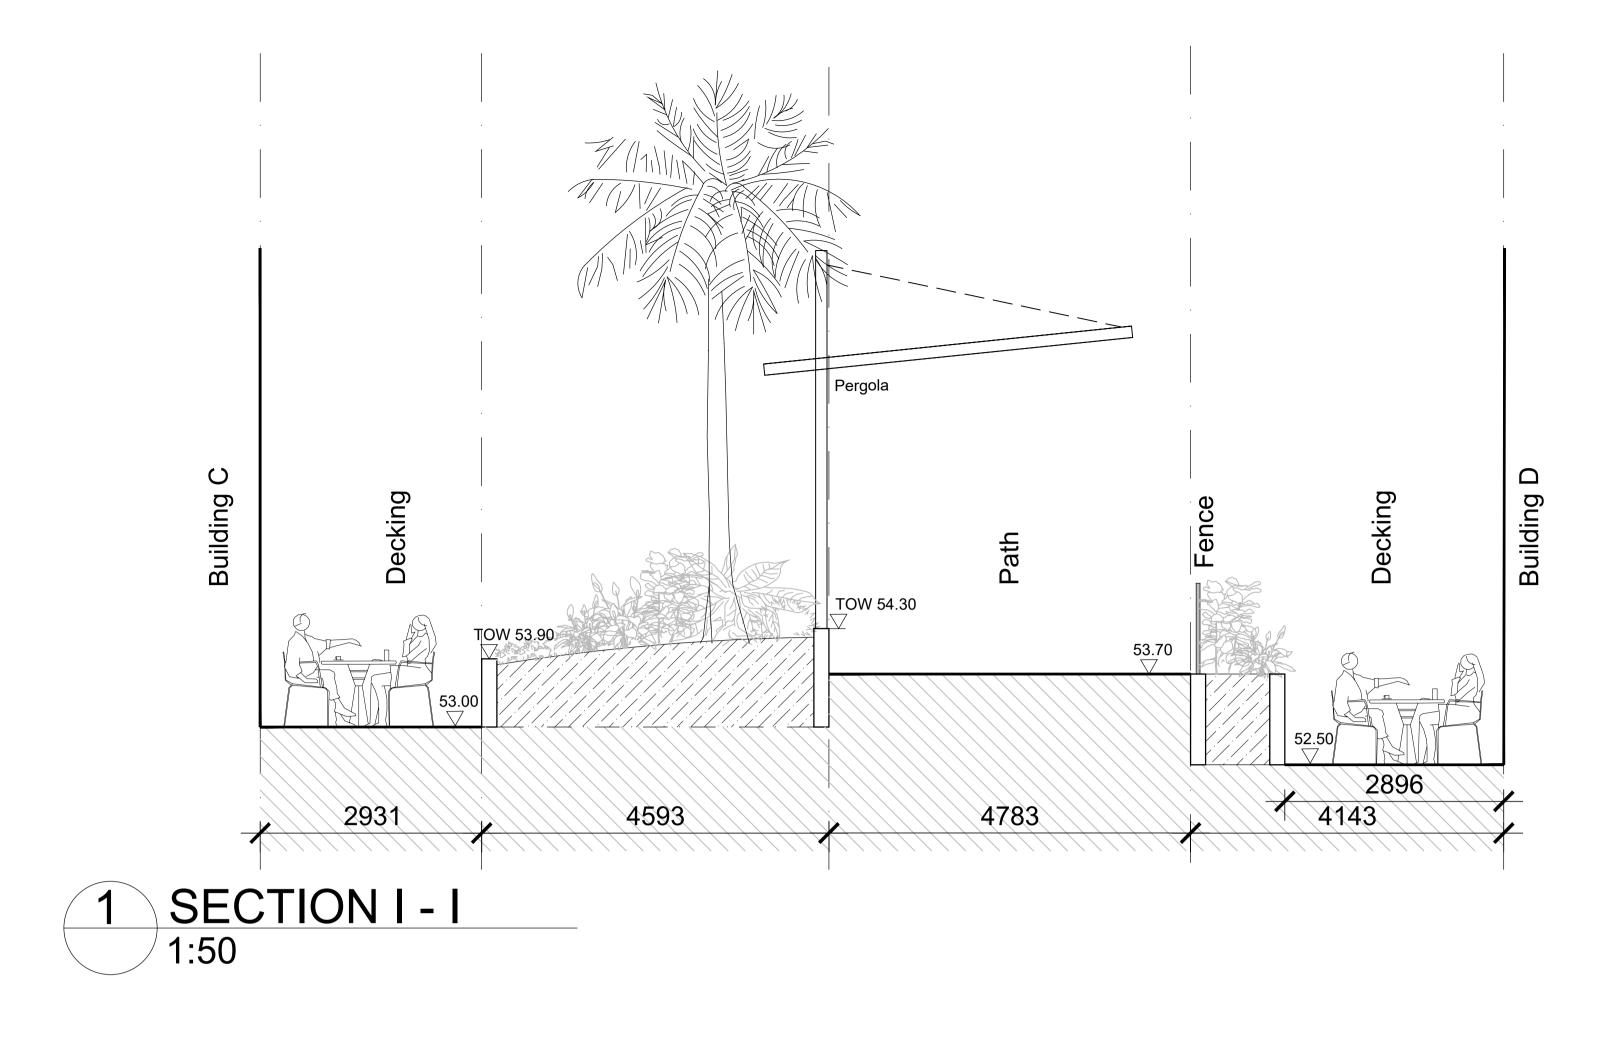
DEVELOPMENT APPLICATION


Landscape Sections

Scale: As Shown Job Number:

Drawing Name:

Sheet _ of _



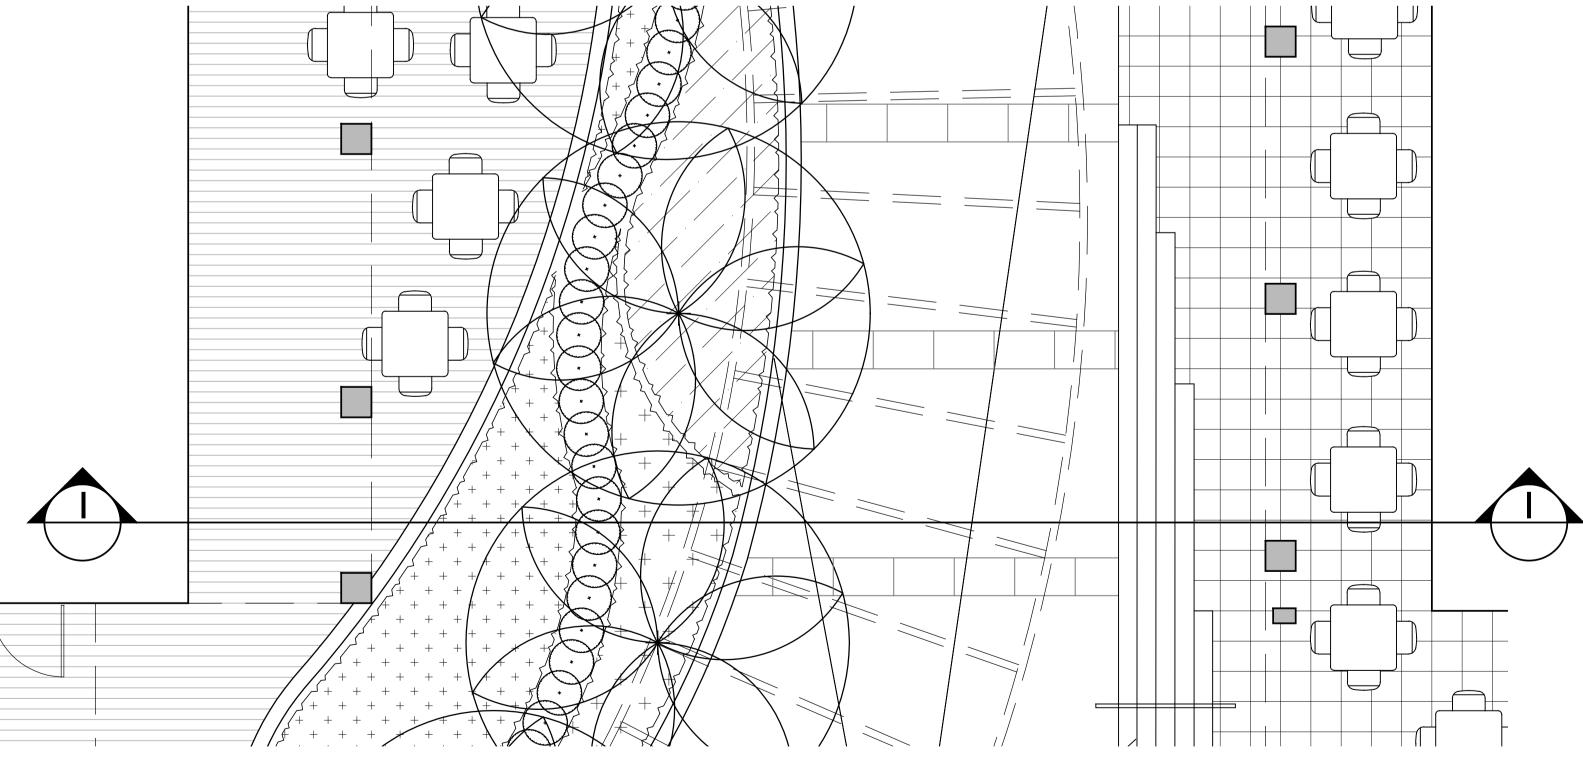







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PH RS 05.07.2021

PH RS 11.06.2021

PH RS 27.05.2021

Drawn Check Date

C For Approval

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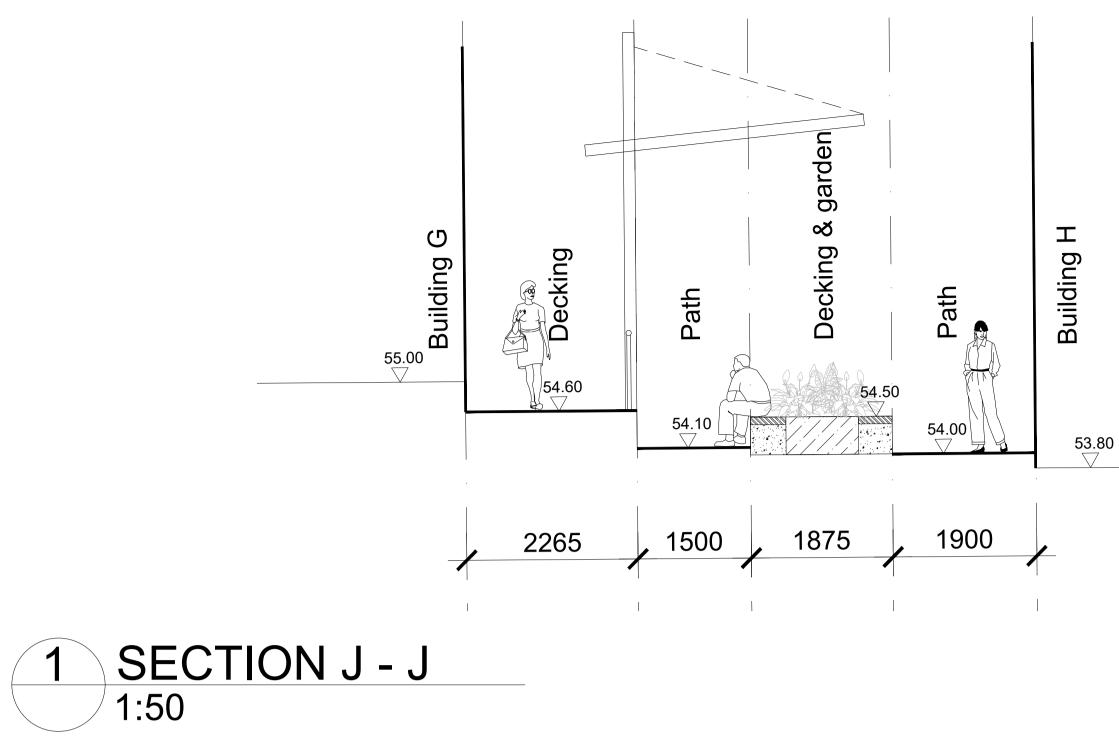
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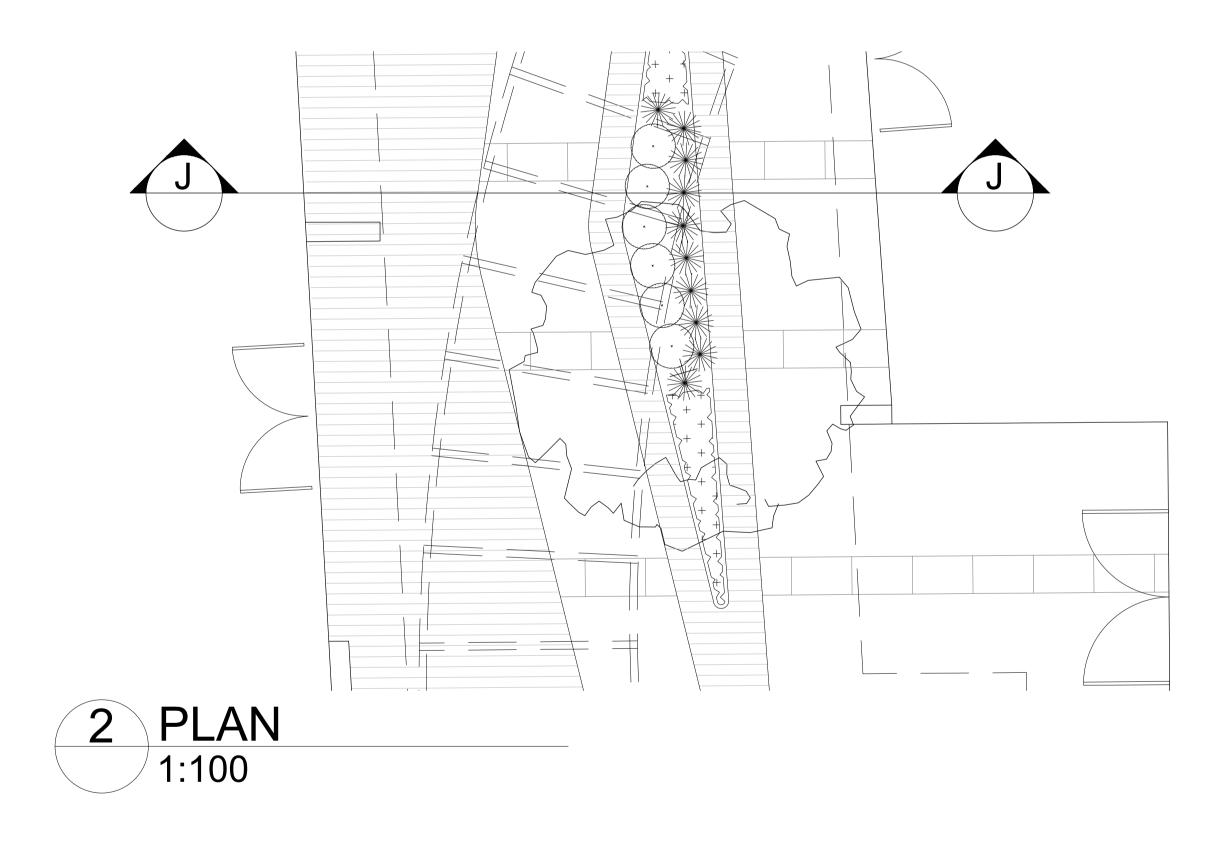
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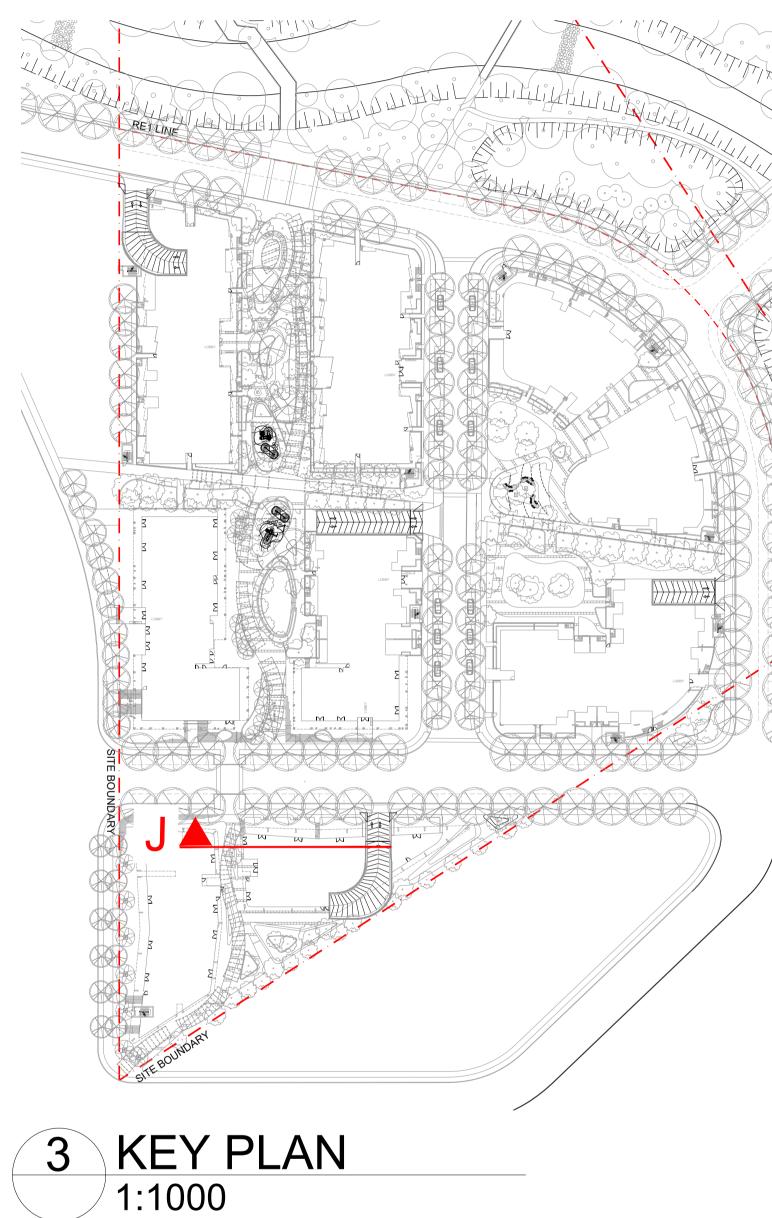
Sheet _ of _

Drawing Numb






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В	For Approval	PH	RS	11.06.2021
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LEGEND

Key Plan:

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Drawing Name: Landscape Sections

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Sheet _ of _

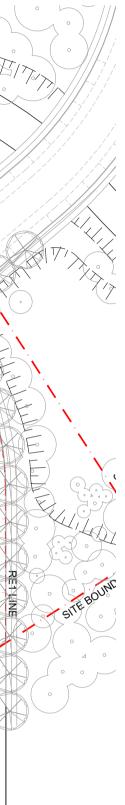Issue:

Drawing Number:

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